

Diamond Drilling Report

on the

F. G. #1 m.c.

7601

Liard Mining Division

104 P/ 4 E

Lat.  $59^{\circ} 13'$  Long.  $129^{\circ} 40'$

owner

The Agnes & Jennie Mining Co., Ltd.

operator

ERICKSON GOLD MINING CORP.

&

NU-ENERGY DEVELOPMENT CORP.

consultant

J. M. Black, PhD. P. Eng.



author

W. G. Botel, P. Eng.

February 25, 1978

JENNIE GROUP

<u>Claim</u>	<u>Record #</u>	<u>Record Date</u>	<u>Owner</u>	<u>F.M.C.#</u>	<u>Issued</u>
F.G. 1	72296 N	16 Oct./74	Agnes & Jennie Mining Co.Ltd.	159,178	Jan.3/78
F.G. 2	72236 N	22 Oct./74	Agnes & Jennie Mining Co.Ltd.	159,178	Jan.3/78
SKY	262	21 Mar./77	Agnes & Jennie Mining Co.Ltd.	159,178	Jan.3/78
SNO	63	28 Oct./75	Kristian Ross	159,179	Jan.3/78
SUN	13	11 July/75	Kristian Ross	159,179	Jan.3/78
KAT	56	16 Oct./75	Mihkel Kangro	159,526	Jan.25/78
Jennie Ext.1	4932 M	18 Sept/56	Table Mountain Mines Limited	159,343	Jan.11/78
Jennie Ext.2	4921 N	18 Sept/56	Table Mountain Mines Limited	159,343	Jan.11/78

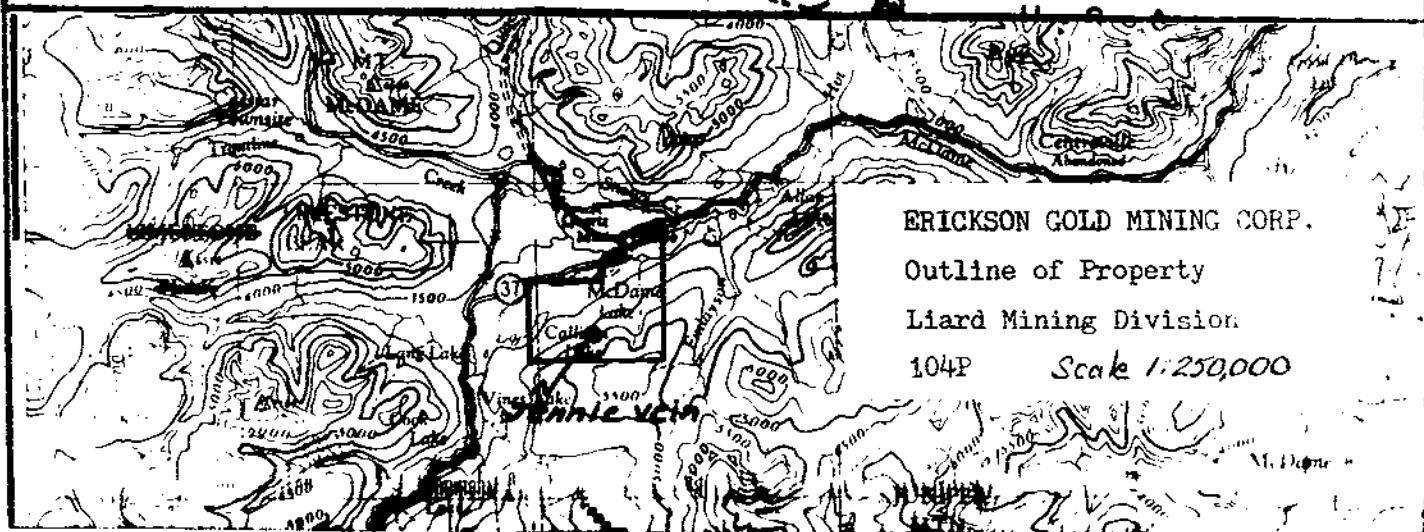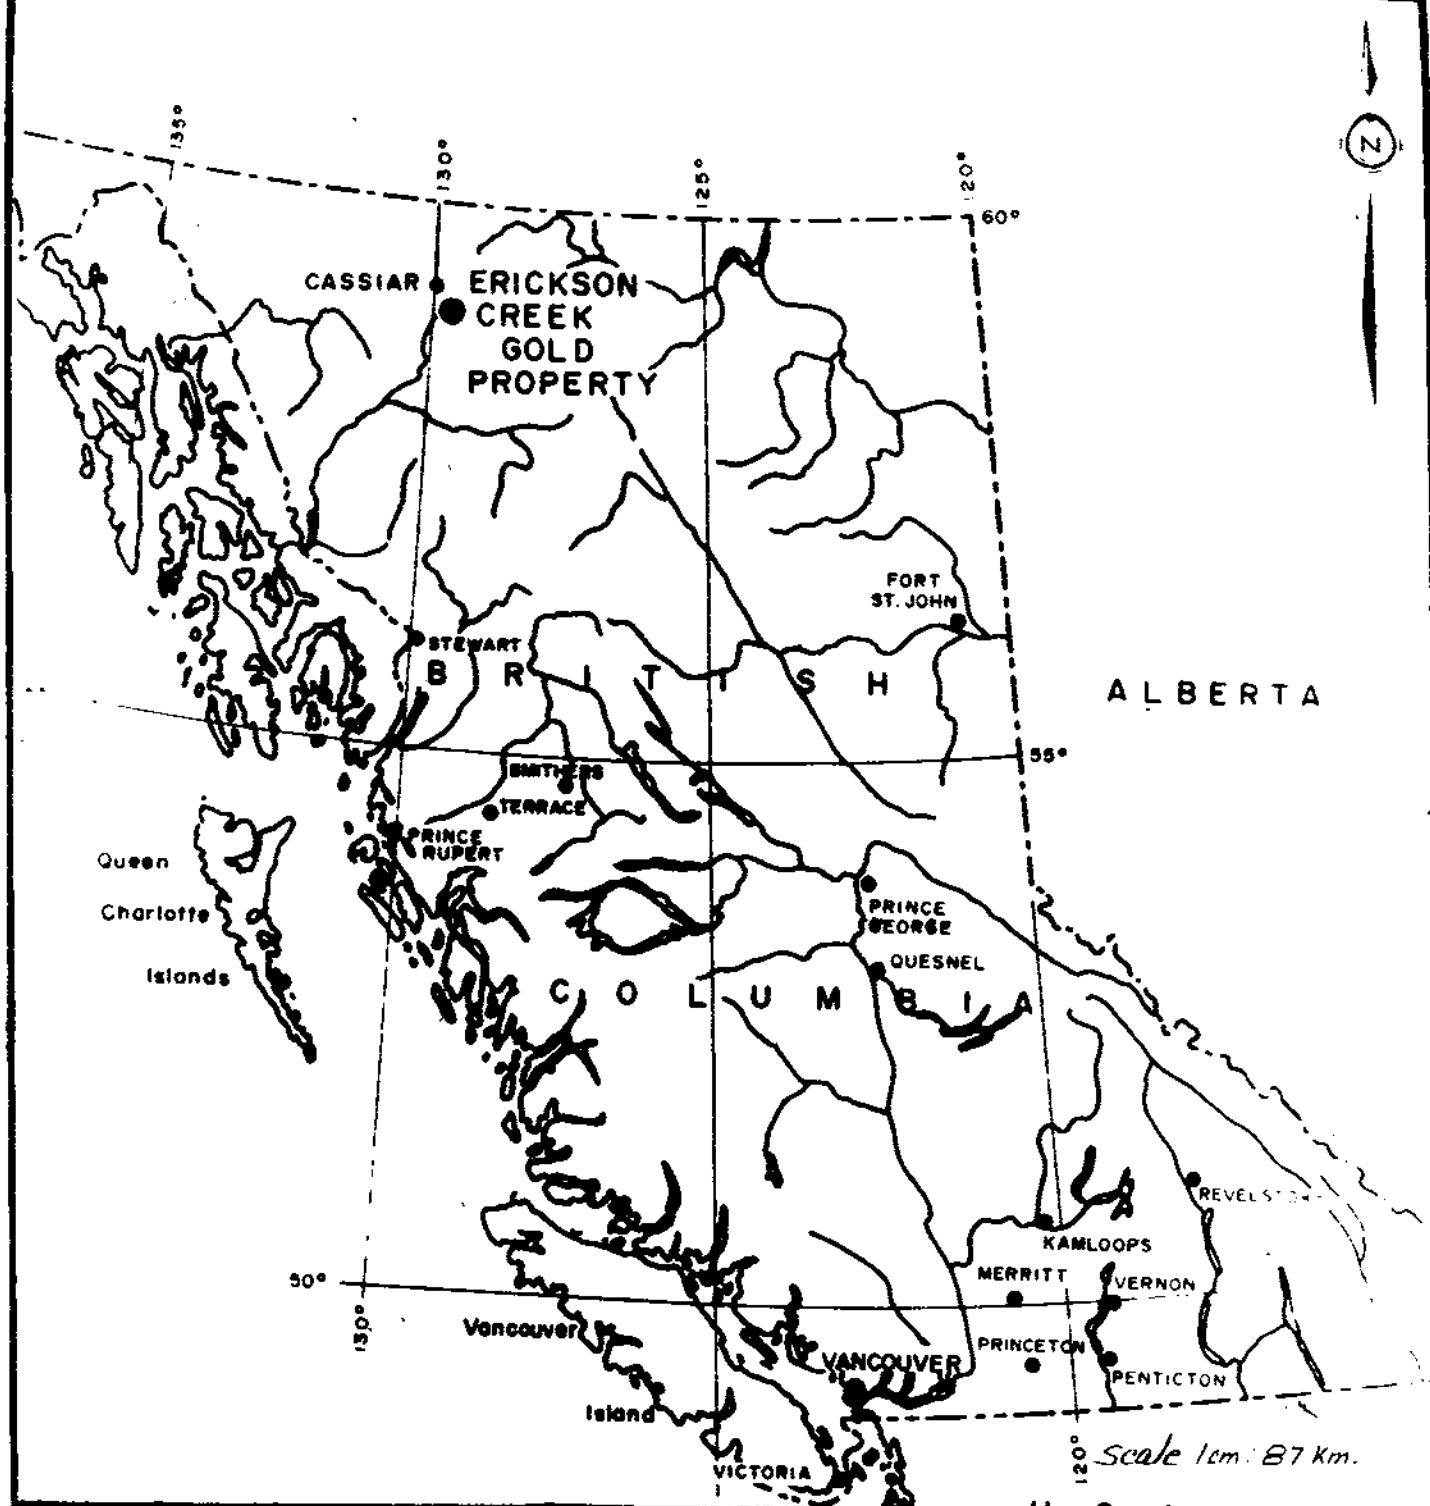

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Topographic Composite Plan; Claims, Diamond

Drill Holes, and Geophysical Grid. Scale 1:5000

Sheet #1 , Fig. # 1

Topographic Composite Plan; Claims, Diamond

Drill Holes. Scale 1:5000 Sheet #2 , Fig. # 1

Longitudinal Section of the Jennie Vein. Fig. # 11

Diamond Drill Log Sheets

- | -

INTRODUCTION

The Jennie vein of the Erickson Gold Mining Corp.'s property was discovered in 1935 by Hans Erickson. The Crawford group located on the south side of McDame Lake also forms part of the property.

This report is based on field work consisting of diamond drilling, underground exploration and geophysics carried out in 1977 and January 1978.

LOCATION AND ACCESS

The Erickson Gold Mining Corp. property is located on the north slope of Table Top Mountain between 930 m. and 1500 m. elevation and lies west and south of highway 37 from the Cassiar road junction. The Jennie vein outcrops in Erickson Creek at about 1400 metres.

Access is by highway 37 from the Alaska highway - 80 miles, or by Kitwanga - 407 miles. The property road leads south from highway 37 at Troutline Creek about 2 km. westerly of the Cassiar junction.

HISTORY

Placer mining for gold in the McDame area started in 1874. A rush followed and several profitable operations existed up the McDame River.

Hardrock prospectors discovered many gold bearing quartz veins in the area. Table Top Mountain was first mentioned in 1936 following discovery of the Vollaug vein and the Jennie vein in Erickson Creek.

Cominco optioned the claims and carried out exploration consisting of trenching and diamond drilling but dropped their option the following year.

A small scale mining operation on the Jennie vein was started by the McDame Lake Mining Company in 1938 or 1939. Approximately 130 tons of ore was put through a 10 ton mill. The reported yield was 11<sup>1/4</sup> oz. Au and 20 oz. Ag.

No further work of consequence was done on the Jennie vein until it was acquired by the Agnes and Jennie Mining Co. Ltd. in 1973.

Preliminary testing in 1973 indicated a mineralized source extending west of the Jennie outcrop. Percussion drilling in the spring of 1975 resulted in some spectacular gold assays over good lengths. Three diamond drill holes were put down through the Jennie vein in September-October 1975 and again the assays were favourable.

Nu-Energy Development Corporation optioned the property in 1976 and carried out a more extensive drilling program consisting of 18 Winkie drill holes in 1976 and commenced an underground exploration program in January 1977. The underground work consisted of a cross-cut adit collared 235 metres N 30° W of the Jennie vein outcrop in Erickson Creek and 61 metres lower in elevation. This adit cut the Jennie vein at

191 m. and was continued for another 36 m. Thirty-six metres of drifting along the Jennie vein cut through the lower section of the ore-shoot outlined by the previous surface drill holes. Underground drilling of 27 holes during February, March and April 1977 further outlined the vein.

Surface drilling of 29 holes in the summer and fall of 1977 extended the dimensions of the vein laterally to the west and downdip while, at the same time, indicated more ore shoots. Surface drilling was completed in October 1977. Drifting to the west along the Jennie vein started in December 1977 and was completed in January 1978 following a decision by the operators and their consultant, J.M.Black, Phd. P. Eng. that enough ore was in sight to justify production at 100 - 150 tons per day.

SUMMARY

A total of 29 holes with an aggregate of 2,559.0 metres were drilled on the FG 1 mineral claim during the period July 1977 to October 1977. Five holes totaling 352.4 metres were drilled on the Gold Hill claims during the period June 1977 to July 1977. All holes were drilled BQ size.

PURPOSE

The purpose of drilling the 29 holes on the FG claim (see Figure #1, Sheet #1 for location) was to test the westerly and downdip extension of the Jennie vein and to outline as many gold bearing ore shoots as possible.

Gold Hill claims: Drilling on the Gold Hill claims - hole Nos. 77 - 28 to 77 - 32 (see Figure #1, Sheet # 1 for location) was to test known silver and gold bearing quartz veins at depth.

Holes 77 - 28 to 77 - 31 cut quartz veins hosted in green volcanic flows and/or tuffs. The best assay received ran 0.05 oz Au/Ton and 2.64 oz Ag/Ton. The remainder were much lower and not of economic interest. The minor visible gold found is probably due to surface enrichment. (See Drill log sheets 1 to 6)

Hole 77 - 32 passed beneath a wide exposure of quartz vein which may have a very flat dip.

RESULTS: Jennie Vein

The 29 diamond drill holes on the FG 1 mineral claim cut the Jennie vein, or a void formerly occupied by the vein, in all instances.

The Jennie vein as cored and seen underground is a very persistent vein composed of probably several stages of quartz. It occupies an east-west steeply dipping fault zone which has had relatively continuous movement, as is evidenced by vein shearing, ribboning, dyke intrusion and films of carbonaceous material. The vein appears to be close to and in part in an argillite (footwall) - tuff contact which with increasing depth dips less than the Jennie vein as the deeper intersections are totally in tuffs and minor flows. The vein thickens and thins and sometimes splits and its attitude can vary quickly. Thickness ranges from a few centimetres to 9 metres. Dip changes from 30° to 90° and in the east drift reverses dip. Length, as presently outlined, from the Erickson Creek exposure to the most westerly diamond drill hole (No. 58) is 260.5 metres. All the indications are that the Jennie vein should continue horizontally in both directions.

Elevation difference between the deepest drill hole intersection (#53) and the shallowest (#63) is 122 metres. The slope distance is much greater.

MINERALOGY

The most common mineral is pyrite - both coarse and fine. Tetrahedrite is also quite noticeable but in variable amounts and contains considerable silver and at times gold. Chalcopyrite is usually found in areas of low tetrahedrite and is indicative of gold. Sphalerite is found in very minor amounts but may also indicate gold.

The gold is generally fine and free. It occurs in definite ore shoots and is not highly visible on cursory inspection.

The indicated ore shoots and drill intersections are shown on a longitudinal section, Figure # 11.

#### CONCLUSIONS

The Jennie vein is strong, persistent along strike and dip and averages over 1 metre in width. Gold mineralization occurs in definite ore shoots which occupy a high percentage of the vein. Grade in the shoots averages over 1 oz. per ton Au. Enough ore is in sight to justify a small mining operation.

#### COSTS

Diamond drilling costs are charged out on a per metre basis and include related costs as follows:

3235.01 metres of BQ diamond drilling	\$163,956.98	\$163,956.98
Mobilization and demobilization	3,695.20	3,695.20
Camp set-up	3,374.39	4/7 of 5,623.99
Engineering	13,785.42	4/7 of 22,975.70
Cat rental	12,236.42	4/7 of 20,394.03
Trailer rentals	4,325.13	4/7 of 7,208.55
Camp and field supplies	22,407.33	22,407.33
Contract bulldozing	1,260.00	1,260.00
Cook - 5 months @ \$1,113.99 say \$1,114.00	5,569.97	5,569.97
Vehicle	2,641.05	4/7 of 4,401.75
Core Storage	800.00	800.00
Assaying 125 samples for Au & Ag @ \$8.00	(1,000.00)	out)
Hole 77-45, 77-46: 13 @ \$8.00	( 104.00)	out)
	\$234,051.89	\$258,293.50

$$\$234,051.89 \div 3235.01 \text{ m.} = \$72.35 \text{ per metre}$$

The diamond drilling occupied a period of 4 months, ie. June 1977 to October 1977 on a two 10 hour shift basis. The program commenced in June with the setting up of camp in preparation for the drill crew. Thus costs of related services are proportioned on a 4 month out of 7 month basis.

Engineering:	W. G. Botel, P. Eng.	= 150 days @ \$100	= \$15,000
	J. M. Black, P. Eng.	= 10 days @ \$150	= <u>1,500</u>
	Total		<u>\$16,500</u>

Diamond drilling on FG 1 mineral claim  
(D.D.H. #'s 34 - 44, 49 to 66) (1977)

29 holes, total metres 2,559.0 @ \$72.35/metre = \$185,143.65

Diamond drilling on Gold Hill group  
(D.D.H. #'s 77, 28 - 32)

5 holes, total metres 352.4 @	\$72.35/metre	= <u>25,496.14</u>
Total cost		\$210,639.79
Assaying for Au & Ag, 103 @ \$8		= 824.00
Report Preparation		= <u>500.00</u>
Grand Total		\$211,963.79



STATEMENT OF QUALIFICATIONS

I, William G. Botel, of 14218 Marc Road, Maple Ridge, B.C. do hereby certify that:

- (1). I am a graduate of the University of British Columbia B. Sc. 1959, a fellow of the Geological Association of Canada and a member of the Association of Professional Engineers of British Columbia. I have practised my profession for 18 years.
- (2). I am the author of this report, which is based upon work under my personal supervision during 1977 and 1978 on the Erickson Creek property of Nu-Energy Development Corp. and Erickson Gold Mining Corp. near Cassiar, B.C.
- (3). While supervising the Erickson Creek property work I was under the direction of J. M. Black, Phd. P. Eng., consultant to Nu-Energy Development Corp. and Erickson Gold Mining Corp.
- (4). I have no interest either direct or indirect in either Nu-Energy Development Corp. or Erickson Gold Mining Corp.

Respectfully submitted,



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William G. Botel, P. Eng.

North Vancouver, B.C.

February 25, 1978

Co-Ords:

## The Agnes &amp; Dennis Mining Co. Ltd.

Hole No. 77-28

Azimuth: 540° E

Diamond Drill Record

Property: Erickson Gold Mining Corp

Dip: -45°

Drill Type &amp; Size: Boyle 17.4 BQ

Location: Gold Hill

Elevation:

for all holes.

Date Started: June 29, 1977

Length: 124.6 m.

Date Completed: July 3, 1977

Section:

Logged By: JSCB Total

Purpose:

Date Logged:

Footage/Metres		Description	Sample No.	Footage/Metres		Length	Au	Ag
From	To			from	to			
1.5	8.0	Andesite, green. Weathered						
	5.4	brecciated						
8.0	10.0	Tuff, grey, oxidized						
10.0	11.0	Tuff, breccia - frags to 10mm. Cubic py to 2mm						
	11.0	Qtz vein - 1cm - 65° to core						
11.0	11.3	Tuff with py cubes						
11.3	11.6	Tuff - faulted - long ang. frags 45° to core						
11.6	12.3	Tuff - massive py cubes						
12.3	13.5	Quartz vein, white, massive. Poss specks tetrahedrite	12.3	13.5		10.003	0.01	
13.5	13.7	Tuff massive py cubes						
13.7	14.1	Quartz vein, brecciated contact with tuffs	13.7	14.1		0.01	0.01	
14.1	14.9	Tuff minor py. cubes						
14.9	15.1	Quartz vein, massive						
15.1	15.8	Tuff grey. py 3% mainly cubes 4 thin gtg. stringers	15.1	15.8		0.012	0.33	
15.8	16.2	Quartz vein - massive, white, barren	65031	15.8	16.2	0.005	0.01	
16.2	18.45	Tuff, black veinlets. 16.3m 8mm 30°. Qtz stringer 16.46m 2cm 45° " " 16.96m 6cm 60° " " 17.3m 7cm 60° " "						
18.45	28.6	Flow-andesite? . e.g. green						
28.6	39.95	Tuff 29.5-31.9 sheared & gtz stringers and py stringers 31.9-32.1 Qtz vein, massive, white, barren	65032	29.5	31.9	0.032	0.21	
			65033	31.9	32.1	0.003	0.01	

Footage/Metres		Description	Sample No.	Footage/Metres		Length	A <sub>n</sub>	A <sub>g</sub>
From	To			from	to			
		36.8 - 20cm g.tz vein	65034			20cm	<0.003	0.02
39.8	40.8	Andesite flow. f.grained, green. 45° contact with						
40.8	71.65	Tuff, grey, dark buff. 3 47.4 - 48.2 : 3'- 50' g.tz stringers + wavy tuff 40.8 - 41.6 : fine py bands in buff tuff. 49.1 - 51 : Light buff tuff - gtz-py dash veinlets 51 - 53.2 : Tuff, altered green 53.2 - 58 : Tuff - broken grey/buff with dash gtz stringers and fine py. Gtz vein with py. along associated zone. in tuff - 54.5 - 55	65035	40.8	41.6	<0.003	0.20	
53 - 66.6		: Sheared tuff - broken with minor gtz stringers and fine py. which shows as dark areas	65036	54.5	55	0.010	0.14	
66.6 - 71.65		: massive f.g. tuff or flow.						
71.65	84.9	Volcanic flow (andesite) green, massive.						
84.9	85.3	Tuff, buff, 60° contact						
85.3	93.7	Volcanic flow - f.g. massive, green.						
93.7	101.0	Tuff - grey - buff 101.6 : 8cm white gtz vein with minor chalcopyrite						
		97.2 - 99.2 - Good f.g. pyrite - 4% . 2 - 20° gtz stringers						
101	112.7	: flow - grey/green, fine grained.						
112.7	116.6	Tuff - greenish buff						
116.6	121	Flow - f.g. green, massive						
121	123	Tuff						
123	124.6	Flow . 40' 3mm gtz stringers.						

H. H. Scott

Sheet No. 77-28 (2).....

Co-Ords:  
Azimuth: S 35° E  
Dip: -44°  
Elevation:  
Length: 54 m.  
Section:  
Purpose:

The Agnes & Dennis Mining Co. Ltd.

Diamond Drill Record

Drill Type & Size:

Hole No. 77-29  
Property: Erickson Gold Mining Corp.  
Location: Gold Hill  
Date Started: July 3 1977  
Date Completed: July 4 1977  
Logged By: H. L. Bell  
Date Logged:

Footage/Metres From	To	Description	Sample No.	Footage/Metres from	to	Length	Au	Ag
0	2.7	Volcanic flow - grey, massive						
2.7	3.0	Tuff, grey - py cubes						
3.0	3.1	Quartz vein - v/s Au in surface cut - in nugs	64968				0.018	0.03
3.1	4.6	Tuff, grey - py cubes diminish away from vein						
4.6	13	Volcanic flow - grey, massive. 15° dips with quartz	64969				0.05	0.02
13	13.1	Quartz vein - rusty, broken. No v/s mineral						
13.1	16.5	Volcanic flow - grey, massive						
16.5	24.5	Volcanic breccia - green with silicous fillings around frags. Tally						
24.5	26.2	Tuff - green/buff becomes pyritic near 26.5 and is brecciated with gte frags - 26-26.2						
26.2	28.6	Quartz vein - massive, white. Tuff inclusions 20cm cf total. Pyrite on margin of tuffs.						
28.6	28.85	Tuff - green, pyritic - poss inclusion within vein - is host.						
28.85	29.7	Quartz vein - rusty, minor 45° py stringers						
29.7	29.8	Tuff py.						
29.8	30	Quartz vein - rusty - minor py						
30	30.3	Tuff - py green						
30.3	30.6	Quartz - with blk of sphalerite and chalcopyrite 4' vein	48540				0.022	2.64
30.6	32.7	Tuff - grey buff, black streaks						
	35.6 - 35.8	Breccia with 10% py + 50 cm quartz stringer.						
	46.8 - 48	broken, related with py - 3%						
	48 - 48.4	25% py - py dark	64967	48	48.4	0.026	0.08	
	48.4 - 49.5	15% py in dark breccia. Some rounded frags.						
	53.7	2nd banded wh/grey py. 1cm. Tetrahedrite, chalc., py.						

Hole stopped in 80' because of broken rod and machine  
malfunction.

Sheet No.....!

Co-Ords:

## The Agnes &amp; Dennis Mining Co. Ltd.

Hole No.

77 - 30

Azimuth: S 15° E

## Diamond Drill Record

Property: Erickson Gold Mining  
Corp

Dip: - 46½°

Drill Type &amp; Size:

Location: Gold Hill

Elevation:

Date Started: July 5 1977

Length: 91.5 m

Date Completed: July 6 1977

Section:

Logged By: H. G. Botal

Purpose:

Date Logged:

Footage/Metres		Description	Sample No.	Footage/Metres		Length	Au	Ag
From	To			from	to			
0	4							
4.0	11.97	Tuff, grey-green surface oxidized. Associated in part 60° py. stringers @ 6.45						
11.7	26.4	Tuff, grey-buff, fine grained 15.3 2cm 25° qtz stringer offsets by joints 22.2-23 qtz vein 20 cm. Slab py + tetrahedrite 30° contacts	5223	22.1	22.3		0.032	0.47
		Tuffs enriched in py on both sides						
26.4	36.7	23.9 - 26.2 Tuff sheared, altered with 2% py. Flow altered, sheared many intersecting garnet veins of carbonate-green						
36.7	47.1	47.1 Tuff or volcanic breccia. Greenish-buff. Mafic black streaks 1-1cm - 30° qtz stringer @ 41.3°						
47.1	91.5	Volcanic flow. Sheeted, talcy, serpentinized, Carbonate veins. Asbestos-form mineral @ 61 m parallel shear.						
		72.3-72.7 - 10° qtz-carbonate stringer. - Fine grained, massive reaction						
		69.6 - 70.2						
		70.2 - 73.8 - buff/green colour						
		75.5 - Sandy fault						
		75.7 - 2cm 25° calcite vein						

Co-Ords:

## The Agnes &amp; Tennie Mining Co. Ltd.

Hole No.

71-31

Azimuth: N 15 W

## Diamond Drill Record

Dip: - 44 1/2

Drill Type &amp; Size:

Property: Erickson Gold Mining Corp

Location: Gold Hill

Elevation:

Date Started: July 7 1977

Length: 50.3

Date Completed: July 7 1977

Section:

Logged By: MCBrath

Purpose:

Date Logged:

Footage/Metres		Description	Sample No.	Footage/Metres		
From	To			from	to	Length
0	2.1	overburden				
2.1	4.0	surface weathered volcanic flow. greenish.				
4.0	13.85	volcanic flow, massive, green, few carbonate veins. Broken 11.8 - 13.85 obsidianitic				
13.85	16.00	Tuff & Shear zone with quartz veins 14.9 - 15.85 white with angular tuff fragments, py cubes				
*	*	50% 15.6 - 16 mainly pyritized black tuff with quartz frags.				
*	16	18.2	tuff breccia - light colour frags in dark matrix.			
18.2	24.8	Flow or Tuff. F.g. massive, green-grey				
24.8	27.8	Tuff or flow, f.g. massive, grey buff with green cast				
27.8	36.3	Flow or grit. green - poss 60° bedding				
36.3	40.5	Tuff. Buff with greenish sections				
*	40.5	40.85 Quartz vein, massive white, 30° contact with py margins slight greenish sericitic.				
40.85	48.3	Tuffs fractured on both sides with black streaks				
48.3	50.3	Tuff, buff, grey 45.4 - 48 sheared 30° rai py. 47.3 48.1 Flow green, gritty, shattered. end.				

Co-Ords:

## The Agnes &amp; Dennis Mining Co. Ltd.

Hole No.

77-32

6

Azimuth: N 62 W

## Diamond Drill Record

Property: Eudsoon Gold Mining

Dip: -43

Drill Type &amp; Size:

Location: Gold Hill

Elevation:

Date Started: July 8 1977

Length: 32m

Date Completed: July 8 1977

Section:

Logged By: H. Abbott

Purpose:

Date Logged:

Footage/Metres		Description	Sample No.	Footage/Metres		Length	An	Ag
From	To			from	to			
0	3	overburden						
3	6.8	Tuff, broken, weathered, altered grey & pyritized.						
6.8	32	4.5 - 6.8. Mixed Qta (mix) + Tuff with py. Tuff associated - fault. 6.5001 Floor green, talc - 11.5 to 16 shear planes. Minor thin carbonate veins. May be gritty. 23.3 - 23.6. Poss. Sulfaceous bed	4.5	6.8		0.01	0.08	

This hole passed below wide exposure of quartz vein.

Co-Ords:  
24.09N : 32.63 N.W.

Azimuth:

Dip: -90°

Elevation: 1011

Length: 45.75m

Section:

Purpose:

## The Agnes &amp; Dennis Mining Co. Ltd.

## Diamond Drill Record

Hole No.

77-34

Drill Type &amp; Size:

Property: Erickson Gold Mining Corp  
Location: FG 1 m.c

Date Started: July 13 1977

Date Completed: July 16 1977

Logged By: Hobart

Date Logged:

Footage/Metres		Description	Sample No.	Footage/Metres		Length	An	Ag
From	To			from	to			
0	11.6	overburden						
11.6	24.9	Argillite, thin bedded 50° light tuffaceous frags on bedding planes mariposite minor pyrite. Some bedding 40° mariposite refined to lighter colored material						
24.9	29	Argillite - 40-45° bedding. Fault zone. parallel gte veins altered. rusty decomposed.						
29	32	Argillite bedding mainly 25° rock broken for last meter.						
32	32.4	Dyke section broken.	52227				1.760	0.64
* 32.4	33.53	Qtz vein (Imrie??) True width 7cm. Contacts 30°. Vis gold 64970 near margin of a rusty, wavy, 1-3mm fracture - 30° - But gold actually in quartz.					8.99	1.06
32.53	33.27	Argillite altered 45° bedding siliceous.	52226				0.086	0.27
33.27	33.47	Dyke & fine py. Contact 55°						
33.47	33.60	Fault 50° healed. qtz fragments. Dyke intrudes re-healed fault						
33.60	33.70	Siliceous rock.						
* 33.70	34.45	Qtz vein (Valentine?) slight rusty colour. One speck gold. upper contact 70°; lower 25°	64971				0.423	0.45
34.45	34.55	altered argillite						
* 34.55	34.65	Qtz vein contacts 30° + 25° no vis gold. but nice looking. 64972					0.014	0.08
34.65	35.7	Fault re-healed, 25°, subrounded qtz frags. Dark.						
35.7	37.5	Fault zone, broken argillite, py cubes, semi parallel						
37.5	40.6	Very siliceous tuffs/argillite. Minor gte stringers, gash veins						
40.6	45.75	Tuffs slightly silicified. Bedding indeterminate. But maybe 30°.						

Co-Ords: 79°N - 102°W  
24.09.mN 32.63.mW

Azimuth: S 72°W

Dip: - 77

Elevation:

Length: 39.96 m

Section:

Purpose:

The Agnes & Dennis Mining Co. Ltd.

Diamond Drill Record

Hole No. 77-35

Property: Erickson Gold Mining Corp.

Drill Type & Size:

Location: F.G. 1 m.s.

Date Started: July 16 1977

Date Completed: July 17 1977

Logged By: H. L. Smith

Date Logged:

Footage/Metres		Description	Sample No.	Footage/Metres		Length	An	Ag
From	To			from	to			
0	13.1	Overburden						
13.1	22.2	Argillite, bedded 70°-80° marcasite in lighter colored sections free of sulf.						
22.2	34.1	Tuff. Faulted 23.4 - 23.7						
24.1	29.7	Argillite bedded 30° to 26.5 then changes to 70° white veining - biotite in Room starts at 28.7 approx.						
29.7	29.9	Argillite - Fault zone.						
29.9	32.6	Argillite - bedded 70° altered silicified gtz veining						
*31.1	31.2	Qtz vein 60° competent - True width 5 cm. One speck Au No r.s. tetrahedrite.	64973	31.1	31.2	0.555	0.36	
32.1	39.96	Tuff. black coloration gradually diminishes to 35.5.						
37.9		Qtz vein 1 cm 30°						
38	38.5	Broken - fault or shear.						
Pyrite cubes in altered argillite 29.7 - 30.9.								
This hole missed larger veins found in 77-34 probably because the hole was to far south. → Qtz section - 3 veins 5-10 cm plus veinlets. Mostly 64974 31.2 32.0 0.012 0.02 wall rocks.								
31.2	32.0							

Co-Ords: 74 N - 102 W  
24 09m N 32.63m W

Azimuth: N 72° E

Dip: -77

Drill Type & Size:

Elevation:

Length: 61.3 m

Section:

Purpose:

### The Agnes & Dennis Mining Co. Ltd.

#### Diamond Drill Record

Hole No.

17-36

Property: Erickson Gold Mining  
Corp.

Location: F.G. 1 m.e.

Date Started: July 17, 1977

Date Completed: July 19, 1977

Logged By: M.C. Boles

Date Logged:

Footage/Metres		Description	Sample No.	Footage/Metres	Length	An	Aq
From	To			from	to		
0	13.1	overburden					
13.1	23.0	Argillite bedded 40°-50° mariposite. tuff fragments. 12.2 - 1 cm 10° gts stringers 14.5 - 16.1 semi parallel gts stringers 16.8 - 17.8 "					
		19.8. ~ 3 cm D tuff frags. rounded. 19.8 - 20.5 gts stringers semi parallel 21.8 - 40 cm 55° gts vein no vis.	65002			0.008	0.08
* 23.0	34	Argillite, talcy. Bedding changes from 50° @ 23.5 to 20-25° 0 cm very talcy section. Also slightly contorted. 26.5. 10 cm basic dyke 85° do mariposite.					
34.0	36.3	Argillite altered, silicified. thin. semi parallel gts stringers					
36.3	37.7 ppm	Argillite, slightly silicified bedding approx 30°					
37.7	39.3	" more " " 40°					
39.3	48.95	Argillite - highly silicified. Also thin gts fresh stringers mariposite @ 42.5. - Bedding 30° @ 48.95-					
* 48.95	49.25	Quartz vein - upper contact 35°? Poorly mineralized.	65003			0.034	0.05
49.25	50.8	Dyke with fine py as before.					
* 50.9	51.0	Tuff with semi parallel py zones. Some fault frags. 5% py.	65004			0.024	0.14
* 52.0	53.25	Dyke apophysis and gts dark margins.	65005			0.098	0.12
* 53.25	53.4	Quartz vein 30° + 15° contacts. Lower contact 3 cm fine py.	65006			0.036	0.20
53.4	61.3	Tuff. solid. slight black staining, breccia in spots no bedding.					

Co-Ords: 164N - 272W

## The Agnes &amp; Dennis Mining Co. Ltd.

Hole No. 77-37

Azimuth: S 29° W

## Diamond Drill Record

Property: Erickson Gold Mining  
Corp

Dip: -78

Drill Type &amp; Size:

Location: F.G. 1. m.c.

Elevation: 1020

Date Started: July 30, 1977

Length: 73.2m

Date Completed: July 31, 1977

Section:

Logged By: M. B. Batale

Purpose:

Date Logged:

Footage/Metres		Description	Sample No.	Footage/Metres		
From	To			from	to	Length
0	11	overburden				
11	20.8	Tuff breccia, rounded frags. - bedding poss. 75° 13.75-14.05 gta vein 45° upper 75° lower barren. Tuff broken, fractured from 18.5 - rusty 30.0 - 15 cm. gauge. dark.				
20.8	28.0	Dark + light bedded rock. - poss. interface tuff to argillite altered, silicified minor gta stringers few 5mm py cubes bedding 70° @ 27.67, broken				
28.0	32.5	5 mm py cubes in argillaceous rock. Tuffaceous, light grey/white with greenish cast. fine grained pyrite 3-5%				
32.5	33.5	T-H, altered, gray. Rounded fragments.				
33.5	50	Argillite, bedded. light + dark marlipsite to 39 m. bedding 60° @ 36.0 m. becomes blacker @ 39. also more talcose. - bedding approx 70° @ 41. 45.1 Fault. also 3cm black gauge @ 42.1 46 - 46.45 white section - soft.				
50		Bedding disappears - altered slightly silicified nodules white grey veins begin				

Footage/Metres		Description	Sample No.	Footage/Metres	Length	Au	Ag
From	To			from	to		
50	58.7	Altered silicified argillite. Minor mariposite. Poss. tuff interbeds. 52.1 - 52.7 leached small holes surrounding round fragments					
	53.9 - 55.2	Fault zone. - Angular dark fragments re cemented by gtz.					
	55.2 - 58.7	Faulted zone - broken core. minor quartz veining. Rock bleached.					
*	58.7 - 59.04	gtz vein. - 30° lower contact with dyke.. white/grey gtz. barren. broken.	65007			0.012	0.12
	59.04 - 60.45	Dyke. upper contact 30° lower, 40° fine pyrite.					
*	60.45 - 63.35	Quartz vein Valentine. True width approx. 4 feet is 1.02 m. 60.45 - 62 solid white few dark bands, barren.	65008			0.003	0.05
*	62.0 - 62.73	reddish brown quartz with very good gold.	65009			0.85	1.21
*	62.73 - 63.35	some chalcocite & tetrahedrite. minor galena greyish gtz, some chalcotrichite, few black bands 65010 1 foot of core lost due to tube not locking. 62.7 - 63.3.				0.152	0.07
	63.35 - 63.85	Fault cemented with gtz - dark grey.					
	63.85 - 66.2	Tuff grey/buff black streaks					
	66.2 - 66.9	Fault revealed by silica 2-3% py.					
	66.9 - 68.9	Tuff greenish/grey massive.					
	68.9 - 69.1	Fault zone.					
	69.1 - 73.2	Tuff - poss. flows. greenish/grey/buff, slightly hint of fine rounded fragments fractured. - 20° end of hole.					

W.G.B.F.T.

Co-Ords: 164 N - 272 W  
50.02 m N - 82.96 W

Azimuth: S 29° W

Dip: -68°

Elevation: 1020

Length: 61.61 m

Section:

Purpose:

The Agnes & Dennis Mining Co. Ltd.

Diamond Drill Record

Hole No.

77-38

Property: Erickson Gold Mining Corp.

Location: 1-67 1 m.c.

Date Started: July 22, 1977

Date Completed: July 23, 1977

Logged By: DCB

Date Logged:

Footage/Metres		Description	Sample No.	Footage/Metres			An	A9
From	To			from	to	Length		
0	9.8	overburden						
9.8	22	Tuff - fragmental beds of pebbles in rounded light fragments in dark matrix, along with greyish massive beds. changes gradually to argillite with tuff fragments around 22.0 1cm py. cubes @ 21.6 bedding may be 60°						
22	24.8	Argillite with tuff fragments minor white gta veinlets @ 60°						
24.8	35.1	Argillite w/tuff altered, bleached silicified white gta veinlets 28.5 - 31.6 minor mariposita						
35.1	32.8	Argillite bedded 50° somewhat wavy. minor low angle gta veins becomes talcy @ 40.0 aka schistosity bedding 60° to core @ 42 50° @ 48						
		Much harder @ 43.5 -> Also large blobs pyrite 48.5 - 51.2 slightly silicified 45° @ 52.7						
32.8	53.88	Gradual loss of bedding attitudes + increased alteration from Altered silicified argillite white veinlets						
53.88	54.50	Dyke very sharp chilled edge contact 60°						
*	54.5	Quartz vein Valentine, broken up. Banded And 54.6, 54.9 - 5cm. some chalco + tetrahedrite. Best area near center 65011	54.5	55.38	1.665	0.90		



Co-Ords: 164N - 272W  
50.02m N' - 82.96m W'

Azimuth: S 29° W

Dip: - 45°

Elevation: 1020

Length: 61.3m

Section:

Purpose:

The Agnes & Dennis Mining Co. Ltd.

Diamond Drill Record

Hole No. 77-39

Property: Erickson Gold Mining Corp

Location: F.G 1 m.c.

Date Started: July 23, 1977

Date Completed: July 24, 1977

Logged By: D. C. Both

Date Logged:

Footage/Metres		Description	Sample No.	Footage/Metres		Length	Au	Ag
From	To			from	to			
0	12.2	overburden						
12.2	18.7	Tuff - grey. breccia. multitude of pea size rounded fragments minor g/t vein ing. lower contact. 40° to 30° g/t stringer						
18.7	20.0	Fractured.						
18.7	26.2	Grey nondescript rock - prob. tuff/argillite - odd 3cm rounded frag. py cubes to 8mm around 20 m, 22.4 m Rock slightly silicified 23.6 - 23.7 Dyke 60° contact. 26.1 - 3cm fault gauge						
26.2	34.25	Tuff. grey/buff to whitish. Py cubes silicified. 26.2 - 26.35 fault gauge.						
	26.7 - 26.9	" "						
	34.25	15mm g/t vein 30° - open but not contact.						
34.25	38.1	Dark partly brecciated tuff/argillite - fractured. 3cm, 20 mm g/t vein at 36.4 Open fracture 37.4 - 38						
37.2	37.4	Dyke - broken up. oxidized						
38.1	42.5	Dyke. - 30° lower contact. 38.9 - 10cm tuff argillite piece. 45° upper edge						
42.5	50.0	Argillite bedding contrasted. white bands. 44.45 - 44.85 Optically mixed by composite 49.5 - 50.0 graphitic 65012					<0.003	0.08
		leached argillite 44.85 - 45.15 ; 46.1 - 46.5						
		48.4 - 40°, 15mm g/t vein						
*	50.0	50.7	Cpt. + argillite mixed graphitic black bands.				<0.003	0.18
*	50.7	50.84	Dyke					



Co-Ords: 164 N - 312 W  
50.02m N 52.46m W  
Azimuth: S 290 W

The Agnes & Dennis Mining Co. Ltd.

Diamond Drill Record

Dip: -82.

Drill Type & Size:

Elevation: 1020

Hole moved N 89° E 1 foot due to hole wanting to follow 77-36.

Length: 71.55m

Section:

Purpose:

Hole No.

77-40

Property: Erickson Gold Mining Corp

Location: F.G. 1 inc.

Date Started: July 24 1977

Date Completed: July 25 1977

Logged By: Webster

Date Logged:

Footage/Metres		Description	Sample No.	Footage/Metres		
From	To			from	to	Length
0	10.4	overburden				
10.4	21	Tuff breccia rounded fragments. 14.17 - 14.3 Qtz vein 65° contact				
21	23	Tuff light coloured dark sections. py cubes. solid.				
23	29.4	Tuff dark. minor narrow Qtz stringers, py cubes to 8mm. partly fragmental. solid.				
29.4	31	Tuff whitish with dark bands streaks.				
31	31.4	Qtz vein. upper contact. 60° white not bedded. upper bedded fault.				
31.4	31.5	Fault. Id.				
31.5	37	Tuff/argillite, moderately altered. in part laminated in part fragmental. minor matrix.				
		minor narrow 35° Qtz stringers.				
		36° of bedding 65°.				
37	50.8	35.5 approx. becomes more laminated argillite Argillite, laminated, bedded, foliose. near 1 to c.a. 240m 45m - 30°; 48m - 55°; 49.5m - 60°				
→ 50.8	51.4	Fault. strong breccias in whitish matrix. 10cm silica 50.8-50.9 slight matrix porosity above, more below (2m) 40° to c.a.				
51.4	54.3	Tuff white. leached. fine py blocks - streaks 2%				
54.3	57.8	Tuff? white/grey not leached. 4% py as rounded cubes to 4mm. slightly fractured.				

Footage/Metres		Description	Sample No.	Footage/Metres		Length	1u	1g
From	To			from	to			
57.8	59.2	Qtz vein, low angle - $15^\circ$ ca. broken						
59.2	59.55	Altered tuff.						
59.35	60.3	Qtz vein low angle. $15^\circ$ ca., narrow	57228			0.018	0.12	
60.3	62.9	Tuff dark, in part fragmental. Broken core. narrow low angle - $10-12^\circ$ Qtz stringers						
62.9	63.4	Qtz vein low angle: - $20^\circ$ included wallrock. narrow						
* 63.4	63.58	Dyke $35^\circ$						
* 63.58	64.93	Qtz vein. black veined-carbon. white - very banded contact for 65015				0.02	0.14	
* 64.93	66.18	Dyke. $30^\circ$ upper contact (sharp) with above gneiss vein. dyke scattered near bottom.						
* 66.18	67.71	Quartz vein - Valentine? slightly banded, colored by rust. no vis. Au. Tr. chalc no tetrahedrite. banding $30^\circ$ . lower contact. $40^\circ$	65016			0.014	0.22	
67.71	76.55	Tuff, greenish, massive.						
	68.2 - 71.5	Bddy broken core. fracture zone. $40^\circ$ ? and 7.55?						

22/3/74

Sheet No.... 77-40...1.1.

Co-Ords: 164N - 272W  
E 02m N 32.96 m w

Azimuth:

S 29° W

Dip:

-55°

Drill Type &amp; Size:

BQ 174.

Elevation: 1020

Length: 60.1m

Section:

Purpose:

## The Agnes &amp; Jennie Mining Co. Ltd.

## Diamond Drill Record

Hole No.

77-41

Property: Erickson Gold Mining Corp

Location: F.G. 1 m.c.

Date Started: July 25, 1977

Date Completed: July 27, 1977

Logged By: D. P. Stott

Date Logged:

Footage/Metres		Description	Sample No.	Footage/Metres		
From	To			from	to	Length
0	11.3	overburden				
11.3	19.8	Tuff brecciated rounded fragments bedding 50°? (14.7)				
19.8	24.9	Tuff - argillaceous in places. 5mm py cubes 19.8 - 21.3 - some fragmental beds?				
24.9	34.3	Tuff - light & dark grey - prob interbeds between frag. tuffs & argillite below. dark nondescript areas maybe alteration. 27.0 - 5 cm corner of grey dyke - similar to Volvafing dyke				
26.0	- dyke	30.5 - 1 cm dyke - 25° to c.a. - one side open fracture.				
		31 - 32.9 very light colour with mariposite also few fragmental pieces.				
		32.9 - 33.1 - argillite bed				
		33.4 - 34 Fault. rock swells				
34.5	49.3	Argillite bedded. - contact with tuffs is gradational. mariposite - to 37.3 but quick. bedding 70° @ 35.5 add large 1cm py xl				
		70° @ 41.5				
dyke - 42.3 - 45		35° @ 41.3 55° @ 43.9				
		36.6 qtz vein white clear 3 cm barren				
		37.3 10 cm qtz vein white pass. shear 37.2 - 39				
		mariposite below 45° numerous white stringers from 40 m				

Footage/Metres		Description	Sample No.	Footage/Metres			Length	Au	Ag
From	To			from	to				
*									
34.5	49.3	see page 81 bedding $45^\circ @ 47$ $60^\circ @ 51.5$ argillite much more siliceous from 47.0 on							
49.3	51.85	Sil. Argillite with numerous gtz. gash veins. Bedding still recognizable							
51.85	52.75	Dyke lower contact $53^\circ$							
52.75	52.85	Fault contact with Valentine vein.							
52.85	55.0	Valentine vein via An on <del>the</del> fracture $70^\circ @ 54.44$ (Jennie) " An spckd @ 54.60.							
*									
53.85 - 53.99		lower contact of vein $60^\circ$	65017				0.112	0.73	
53.99 - 55.00			65018				3.500	0.59	
55.0	56.7	Tuff fragmental as faulted on lower contact of vein. 53329					0.005	0.15	
56.7	60.1	Tuff massive greenish sandy. Brown/buff zones patches. end 60.1							

2/30/67

Sheet No... 77-41....2...

Co-Ords: 164 N - 272 W  
50.02m N 82.96m W

Azimuth: 5 54° W

Dip: -73

Elevation: 1020

Length: 66.5m

Section:

Purpose:

### The Agnes & Dennis Mining Co. Ltd.

#### Diamond Drill Record

Hole No.

77-42

Property: Erickson Gold Mining Corp

Location: E.C. 1 m.c.

Date Started: July 27, 1977

Date Completed: July 29, 1977

Logged By: J. C. Scott

Date Logged:

Footage/Metres		Description	Sample No.	Footage/Metres			Length	Au	Ag
From	To			from	to				
0	10.4	overburden							
10.4	21.96	Tuff breccia rounded frags. greys. few py blobs up to 1cm.							
21.96	34	Tuff - more massive (cohesive) light to dark grey. larger frags. but fewer in number minor gte stringers from 23.7 29.3 - 30.8 much lighter colour greenish. minor py blobs up to 1cm.							
*		31.3 - 33.5 Fault zone with 35° gte vein							
	32.8 - 33.1	gtz vein - 20° py stringer	65019					3.380	0.92
	33.1 - 33.6	Fault breccia - solid. gte frags rounded + argillite frags bedded.							
34	36.8	Argillite / Tuff - interbedded							
36.8	52	Argillite bedded marlposito to 31.2. Black. bedding 65° @ 37							
	36.8 - 37	- open fractures with gte 1/3							
	38.4 - 38.9	Fractured							
	39.4 - 40	; 44.2 - 40 ; 45.9 - 40 ; 50.5 - 45 ; 52 - 40							
	40 - 48.4	fracture							
	48.4	Silicification begins - also minor gte stringers 1cm							

Footage/Metres		Description	Sample No.	Footage/Metres			Length	Au	Ag
From	To			from	to				
52	58.7	Altered, bleached Tuff. light grey/greenish. quartz stringers - 25° - 45° 3 mm py 2½% after 55.8 - 56.3 Fault with 20cm semi parallel gte - py 10-60° 2mm 57.5 - 58.25 - Light grey very quartzose - 1-30; 3mm gte vein 58.25 - 58.4 Fault. marbles							
*	58.40	58.7 Quartz vein - white barren. lower contact 50°	65020				0.01	0.08	
	58.7	- 60.10 Dyke. upper contact 50°, lower c. 45°. Blocky							
	60.10	64.4 Quartz vein Valentine with vis Au 2 60.71, 60.86, 61.10 63.8. Banding 50° to c.a.							
#	60.10	60.69 Quartz vein - milky white - little banding.	65021				0.003	0.02	
*	60.69	61.50 "	65022				1.084	0.90	
*	61.50	62.2 Altered rock (as 57.5-58.25) inclusion?	65023				0.584	0.26	
*	62.20	63.13 Quartz vein, nicely banded - 50° good colour. i.e. rusty.	65024				0.024	0.36	
*	63.13	64.4 Quartz vein, broken, poor banding, 1 piece vis. Au. recovery in this section 70%.	65025				0.030	0.08	
	64.4	66.5 Tuff grey/buff. massive minor parallel gte stringers.							

M. G. T. J.

Sheet No. 77-42-1.....

Co-Ords: 164N - 272W  
50.02m N 02.96m W  
Azimuth: S 54 W

## The Agnes &amp; Dennis Mining Co. Ltd.

## Diamond Drill Record

Dip: - 62

Drill Type &amp; Size: BD 17A.

Hole No. 77-43  
Property: Erickson Gold Mining Corp.  
Location: E.G. 1 m.c.

Elevation: 1020

Date Started: Eng. July 29, 1977

Length: 68.93m

Date Completed: July 31, 1977

Section:

Logged By: Mello

Purpose:

Date Logged:

Footage/Metres		Description	Sample No.	Footage/Metres	Length	Au	Ag
From	To			from	to		
0	11.6	overburden					
11.6	24.4	Tuff - fragmental slightly rounded light grey fragments as before. mostly 0-10 mm. core slightly darker matrix. 21.3 - 24.4 - Fewer fragmentation, lighter colour. 13.63 - 13.8 qtz vein white barren					
	13.1	- 3cm qtz vein barren.					
24.4	33.8	Mixed Tuff/jacellite - nondescript dark + light grey. minor qtz fragments. various angles..					
	36.17 - 36.9	Jaculte gauge since my notes at 36.6, 37.9					
	38.3 - 39.8	shear zone. fine blabs py rock soft.					
33.8	40.95	Argillite bedded, laminated, but still has tuffaceous fragments & poorly developed bedded. marcasite. 36.6 - 38. very light green (marcasite) rock   minor white veins 38 - 51.0 well bedded. 70° - 75°					
	47.7 - 49.	bedding change due to slip or shear.					
	52 - 53.1	Shear. leached					
	53.1 - 53.9	Seams parallel qtz vein milky.					
	53.1 - 60.95	Silicified slightly - also has white sections with minor marcasite - Probably altered section.					
	Heavy leaching of dark argillite - leaving holes @ 54.9 - 55.4;						
	56 - 56.2 ; 58.8 - 59.3 ;						
	59 - 59.95	59.230	59	59.45		0.005	0.07



Co-Ords: 224 N - 417 W  
68.32m N 127.18m W  
Azimuth: Due S

## The Agnes &amp; Dennis Mining Co. Ltd.

## Diamond Drill Record

Dip: - 68°

Drill Type &amp; Size:

Hole No. 77-44  
Property: Erickson Gold Mining Corp.  
Location: F.G. 1 m.c.

Elevation: 1028

Date Started: July 31, 1977

Length: 83.27m

Date Completed: Aug 2, 1977

Section:

Logged By: D. Elston

Purpose:

Date Logged:

Footage/Metres		Description	Sample No.	Footage/Metres	
From	To			from	to
0	17.08	Overburden - Prob. decomposed argillite in part.			
17.08	22.51	Striking! Black + grey Argillite. evidence of slumping. -fragments diamictitic bands. Bedding 40° to c. 0.03 20.74 50° . . . 21.96 Becomes greyer towards bottom.			
22.51	26.54	Py common 26 Tuffs grey, light grey rounded fragments in dark matrix. Bedding of frags 50°? Contact with argillite extremely sharp, sheared with 3cm impure quartz vein at 50°.			
26.54	44.23	Tuffs only a few fragmental horizons - remainder grey/dark grey massive. 29.81 - 31.1 Py cubes to 6cm. irreg. 32.33 2.5 cm 55° g/tz vein barren. 33.85 1 cm 35° g/tz vein "			
		37.21 - 37.51 Mud seam - shear or fault			
		39.65 - 40.11 Mud seam - "			
		40.72 - 40.87 Mud seam - with quartz.			
		41.02 - 42.7 parallel fracture			
		42.85 - 44.22 Black with py cubes. minor hairlike g/tz stringers.			
44.23	51.24	Tuffaceous argillite poorly bedded. 40° @ 44.53 light grey 60 @ 48.8 altered, leached, oxidized. minor g/tz stringers + py.			



Co-Ords: 396N - 304W  
120.78m N 107.97m W  
Azimuth: S 1 E

## The Agnes &amp; Jennie Mining Co. Ltd.

## Diamond Drill Record

Hole No. 77-49

Property: NV ENERGY

Dip: -45°

Drill Type & Size:

Location: F.G 1 m.c.

Elevation: 947

Date Started: Aug 20, 1977

Length: 102.18m

Date Completed: Aug 22, 1977

Section:

Logged By: DSBot

Purpose:

Date Logged:

Footage/Metres		Description	Sample No.	Footage/Metres	
From	To			from	Length
0	15.25	overburden - also permafrost			
15.25	17.39	Tuff olive/green with 1-2mm dark, rounded, spots.			
17.39	18.40	Tuff altered dark			
18.40	19.15	Tuff altered white with black			
19.15	19.50	Tuff light cream/grey			
19.50	21.7	Tuff altered - shades of grey & black.			
21.7	26.1	Argillite, black massive. Some lighter tuff fragments. minor veining			
26.1	27.2	Interbedded argillaceous Tuff. light grey with black argillite frag.			
27.2	28.65	Argillite blocks			
28.65	30.1	Tuff altered. light grey black streaks minor diss. py			
30.1	30.81	Argillite - bedded about 70° (crudely)			
30.81	45.3	Lagilli Tuff. light grey/green fragments in dark matrix. frag 1mm - 1cm. angular. 3mm commonest. very minor gte veining			
	42.75 - 43.65	rusty 70° gte vein barren			
	30.81 - 31.65	light matrix			
45.3	54.5	Argillite black, bedded, Fault zone 47.7 - 50.94 minor marlstone 50.94 - 54.5. very talcy bedding. 75° @ 46m 65° @ 52.5m			
54.5	57.65	Argillite/Tuff contact is gradational Tuff. grey.			

Footage/Metres		Description	Sample No.	Footage/Metres			Length	Tu	Ag
From	To			from	to				
57.65	70.5	Volcanic flow - green darker streaks and patches gtz veins 61.9 - 5 cm $50^\circ$ barren 64.4 - 1 cm $35^\circ$ rusty 68.8 - 3 cm $50^\circ$ barren							
70.5	89.64	Tuff cream/green or altered flow. gtz veins. 70.5 - $30^\circ$ 5 mm 71.1 2 - $30^\circ$ 5 mm with py 80.8 2 - $30^\circ$ 1 cm minor py 73.1 $35^\circ$ 73.2 - 74.7 - 3% fine py in light cream Tuff or altered flow 76.9 - 77.2 5% " " " " with marcasite							
89.64	88.45	Argillite with Tuff fragments Breaks 87.6 - 88.45							
88.45	93.64	Tuff creamy/grey minor gtz stringers							
*		92.35 5 mm $20^\circ$ gtz stringer - very minor galco 92.9 - 93.64 2 cm semi parallel gtz stringer with Au specks at 93.62 50% gtz, 50% rock!	65057					0.022	0.10
*	93.64	Dyke							
*	94.40	Val. Vein 26" or 0.66 m lost. slightly oxidized, minichlorite 313½ 65055						0.020	0.16
*	95.92	96.38 Argillite, impure grey/black py cubes							
*	96.38	96.69 Gtz vein oxidized over 96.38 30% rock.	65057					0.014	0.12
*	96.69	98.2 Argillite, impure grey/black grades into Tuff							
98.2	102.18	Tuff/argillite - grey to black. minor $50^\circ$ gtz stringers. end 102.18.							

11/8/60 TD

Co-Ords: 396 N - 354 W  
120.18 N 107.97 m W

Azimuth: S 1° E

Dip: -60 Test at 401' -70° Drill Type & Size:  
122.3 m

Elevation:

Length: 122.31

Section:

Purpose:

The Agnes & Dennis Mining Co. Ltd.

Diamond Drill Record

Hole No. 77-50

Property: Erickson Gold Mining Corp.

Location: F.G. 1 m.c.

Date Started: Aug 22, 1977

Date Completed: Aug 24, 1977

Logged By: M. B. B.

Date Logged:

Footage/Metres		Description	Sample No.	Footage/Metres		
From	To			from	to	Length
0	15.86	overburden				
15.86	20.3	Tuff, white & dark grey, cracked. Brown pyrobitite spots to 15.86 - 16.5 ; 20 - 20.3				
20.3	32	Tuff light cream/buff, dark streaks Fragments. 20.3-22.5 Brown pyrobitite spots. 25.7 - 25.9 Good fine pyrite 5%				
		26.4 - 32 Fine spots pyrite				
		24 - 25 Vuggy, oxidized				
32	32.6	Tuff/Argillite transition				
32	39.1	Argillite/Tuff. Blackish bedding at 36.7 - 37.2 = 45° 34.3 - 38.74 vuggy, secondary gte crystals minor pyrite 38.54 - 38.74 Qtz, carbonate vein - vuggy				
39.1	42.54	Tuff lapilli grey dark matrix				
42.54	44.43	Argillite with some Tuff fragments minor py				
44.43	47.1	Tuff lapilli then into argillaceous lapilli tuff - Grades.				
47.1	57.7	Argillite - thin bedded, talc 60° bedding at 49.7 49.87 - started very talc argillite Tuff fragments in argillite				
57.7	60.12	Tuff - gray/buff - swells. Poss. fault alteration zone.				

Footage/Metres		Description	Sample No.	Footage/Metres		Length	Au	Ag
From	To			from	to			
60.2	64.5	Flow green f.g. massive, hard.						
64.5	65.4	Siliceous section - gray - Poss tuff. barren.						
65.4	70	Flow altered palegreen cream specks by 67.6 into normal volcanic flow green						
		70 - 70.55 Siliceous, gray, section as before.						
70.55	71.8	Altered flow - pale green						
71.8	76.6	Tuff - creams, grays, buff. broken. pyrite. # 73.5 2.5 cm 40° g.t.z vein.						
76.6	86.3	Tuff greenish/gray black streaks + patches. 78.65 - 78.8 Qtz-carbonate vein impure. - gray section - semi parallel g.t.z stringers also carbonate 82.2 - 83.15						
		84.3 - 86.3 mariposita = mainly along semi // shear						
86.3	88.9	Tuff gray/green rusty, broken, 2 - 20° 1cm g.t.z perh shgs						
88.9	111.4	Tuff. random. grays - 88.9 - 95.7 py 2% as streaks along semi // shear and disseminations, Altered section. 98.7 - 99.1 low angle brecciated g.t.z-carb. vein minor py.						
		100.9 - on. Qtz stringers - various angles, py cubes 102.1 - 102.4 Barren white g.t.z vein	65058				0.050	0.04
		105.6 - 106.5 Broken - poss. fault. 108.9 - 111.4 Tuff more massive & less fragmental						
111.4	117	Argillite f. impure. bedded 85° -						
*	112.6	112.85 Qtz vein - Carbonaceous suture beds, Poss. Valentine	65059				0.003	0.08
*		barren. Mariposita begins 112.6						
*		Quartz zone continues to 115.8 as stringers, blobs.						
117	119.85 -	113.92 very minor py, magnetite	65060				0.003	0.14
		Tuff altered or Flow Rx. altered. much mariposita minor g.t.z stringers. Specks magnetite @ 122. Some py few leached, vuggy fragments.						
		Intense alteration.						

Co-Ords: 396 N - 354 W  
130.78m N - 107.97m W  
Azimuth: S 28° E

## The Agnes &amp; Dennis Mining Co. Ltd.

## Diamond Drill Record

Dip: -45 ~~77° T-50 -57°~~ Drill Type & Size:

Elevation: 947' approx. 118.

Length: 118.95

Section:

Purpose:

Hole No. 77-51

Property: Erickson Gold Mining Corp

Location: F.G. 1 m.c.

Date Started: Aug 25, 1977

Date Completed: Aug 26, 1977

Logged By: M. G. B.

Date Logged:

Footage/Metres		Description	Sample No.	Footage/Metres			
From	To			from	to	Length	
0	16.47	overburden. Poco gte in a mariposita rock.					
16.47	22.	Tuff-flow. light grey, oxidized, broken					
22	30.50	Argillite/tuff. mixed - black argillite with interbedded & mixed tuff.					
30.50	32.64	Same but fault. lost 184' 3m. core.					
32.64	35.9	Argillite					
35.9	36.0	Ptvein 30° barres. Contact feature.					
36.0	47	Tuff lapilli grey dark matrix - argillaceous. minor gte stringers					
47-	47.3	Contact. fault zone reheated by gte/carb.					
47.3	49.41	Argillite, poorly developed bedding 55° Minor gte stringers					
49.41	56.5	Argillite, laminated. talcy bedding 50°					
56.5	59.9	50.94 3cm 70° gte vein.					
59.9	61.2	Tuff/argillite grey.					
61.2	66	Tuff-flow altered reddish buff					
66-	67.7	Flow green fig. massive. slightly magnetic					
67.7	73.9	Flow altered pale green/buff - grey py for 15cm before 67.3.					
73.9	87.0	Flow - breccia in places. pale green non magnetic					
87.0	89.5	Flow/Tuff. aphanitic pale green/buff, dark horlike streaks					
89.5	93.4	80.7-80.8 25° gte/carb vein intersected & py.					
93.4	103.9	84.95-85.05 3cm py with gte vein on each side 50°					
93.4	91.7	Flow/Tuff dark grey argillaceous material increases					
91.7	93.4	Argillite mixed with Tuff. grey/black. Tuffaceous material increases towards bottom.					
93.4	103.9	Tuff - fragmented shades of grey black streaks.					
		becomes darker grey or more org. like cores					
		99.5 - Ptvein stringers start.					
		ore.					



Co-Ords: 396N - 354W  
120.78m N - 107.97m W  
Azimuth: S 25°30' W

The Agnes & Dennis Mining Co. Ltd.

Diamond Drill Record

Hole No. 77-52

Property: NU ENERGY

Dip: -49 Test -57° @ 108.58 Drill Type & Size:

Location: H.G. 1 m.s.

Elevation: 947

Date Started: Aug 27, 1977

Length: 108.58

Date Completed: Aug 29, 1977

Section:

Logged By: M. G. Tolok

Purpose:

Date Logged:

Footage/Metres		Description	Sample No.	Footage/Metres		Length
From	To			from	to	
0	15.25	overburden				
15.25	18.5	Tuff or flow pale greenish grey. Black streaks + veins massive.				
18.25	26.9	Tuff - Argillite - light grey + black massive becomes more argillaceous towards bottom				
26.9	37.3	Argillite massive. 36.9 - 28 leached 31.3 - 31.7 Tuffaceous section. 31.7 - 32.3 gta stringers 65° - 70°				
37.3	47.31	Tuff grey quite massive. Lapilli 46.1 - 41.8 ; 47.1 - 46.3 43.5 - 45.5 minor 45° gta stringers.				
47.31	55.3	Tuff dark. argillaceous lapilli small py cubes 47.31 - 50.9 many 65° gta stringers				
55.3	58.4	Argillite laminated, talcy 55.9 - 56.0 cpt vein, barren, 60°				
58.4	62	Flow altered very talcy at 58.4 - 59. light grey				
62	66.65	Flow f.g. massive. specks of kaolinated feldspare. green, non magnetic				

Footage/Metres		Description	Sample No.	Footage/Metres		Length	Au	Ag
From	To			from	to			
66.65	71.4	Flow partially breccia partly tuffaceous. Black streaks						
		68.7 3cm 30° gtz vein						
71.4	77.8	Flow f.g green massive - changes at 73 to altered, slightly oxidized rock. May be tuff with minor argillaceous sections & very minor gtz veins.						
77.8	86.3	Tuff dark - slate fragmental shades of dark grey. Minor low angle 15°-20° gtz stringers.						
86.3	88.3	Tuff light greenish gray - poss. altered. 88m: 30° - 2cm gtz part vein ②						
88.3	89.9	Argillaceous Tuff or reverse black 88.8 1cm 10° impure gtz vein. 89.8-89.9 Mixed gtz + argillite vein ② contact & sheared.						
89.9	96.38	Tuff grey, massive, pyrite, gtz stringers, vuggy						
	92.9-93.1	Faulted gtz / quartz vein 50°						
	95.3-95.4	9cm white gtz vein 50° barren						
*	96.38	Quartz vein angular black suture, minor py. no Au 65062	65062			0.012	0.02	
*	97.3	Faulted quartz, fragments. 50°	65063			0.022	0.06	
*	97.45	Dyke with 1-3cm gtz vein - faulted.						
*	97.45	Dyke with 1-3cm gtz vein - faulted.						
*	98.7	Faulted vein contact. some argillite, gte, dyke.						
*	99.1	Quartz vein. White, banded bts carbonaceous sutures. no Au	65064			0.054	0.10	
*	99.74	Quartz vein - same but 1 spec. vis. Au @ 99.97m.	65065			0.144	0.09	
*	100.16	Quartz vein, shattered. Recovery 60cm. only.	65066			0.01	0.08	
*	102.02	Quartz vein white barren.	65067			0.003	0.05	
*	102.02	Quartz vein white barren. Includes 15cm rock ② 103.3	65068			0.005	0.04	
*	102.33	Quartz vein white barren. Argillaceous Tuff with 40% quartz.	65069			0.003	0.06	
*	104.92	Argillaceous Tuff with low angle quartz veins - late?						
*	106.29	Fault re-heated & filled by white quartz ② 107.7 - 108.14 - 20°						
	108.58	End. 108.58.						

W.B.C.

Co-Ords: 396N - 354W

120.78mN - 107.97mW

Azimuth: S 25° 30' W

## The Agnes &amp; Dennis Mining Co. Ltd.

## Diamond Drill Record

Hole No.

77-5.3

Dip: -60° collar -65° indicated @ 48'

127.49m

Drill Type &amp; Size:

Property: Erickson Gold Mining Corp.

Location: I.G. 1 m.e.

Elevation: 947

Date Started: Aug 29, 1977

Length: 434' 129.32m

Date Completed: Aug 31, 1977

Section:

Logged By: JGGold

Purpose: Test down-dip of 77-5.2

Date Logged:

Footage/Metres		Description	Sample No.	Footage/Metres	Length
From	To			from	to
0	15.56	overburden			
15.56	17.30	Light Tuff: pepper spots of pyrochite. 16.9-16.4 Fault. Mud!			
17.30	17.80	17-17.8 Fault. Argillaceous mud. 30° lower contact.			
17.80	18.35	Argillaceous Tuff. Faulted.			
18.35	19.5	Silt. Tuff. white.			
19.5	21.4	Argillaceous Tuff. Faulted - black mud. soft.			
21.4	33.75	Argillaceous Tuff. mud stronger @ 60°. Also faulted. white Tuff. black streaks, patches, pepper spots of pyrochite. 70° upper contact.			
33.75	34.5	Some fragments.			
34.5	35.35	Argillite/Tuff interbed.			
35.35	44.5	White Tuff. pepper spots pyrochite Argillaceous Tuff. dark. Pyrite associated with mud/gtz stringers interbeds of grey tuff.			
42.2	42.34	50 gtz vein			
44.5	59.27	Argillite, massive black. No clear division with argillaceous Tuff. strongly altered i.e. silt. 53.2-59.27. bedding = 6-70° not clear			
59.27	63.85	Tuff or flow grey/green. 1.5m thick for 1st 2m.			
63.85	64.6	Silicified Tuff. - grey - fault & gtz/park vein = lower contact.			

Footage/Metres		Description	Sample No.	Footage/Metres		Length	Au	Ag
From	To			from	to			
64.6	67.4	Volcanic flow. green, white alteration specks = kaolized feldspar? First 30 cm broken. lower contact broken, oxidized.						
67.4	68.93	Silicified tuff? - grey. - gtr pyrite vein - lower contact.						
68.93	94.2	Flow (breccia?) pale greens-greys Fragments blocky. fine diss pyrite 68.93-69.2; 70.2-70.4 70.5 - 4cm - 40° gtr pyrite vein 71.2 - 3cm - 20° gtr pyrite vein. 76.9 - Shear vugs lined with pyrite. 80.2-80.6 shear or fault. broken 83.57 - 85.7 - altered bleached section. Green min (magnetite or copper stain) - 84.4-84.6; 85.2-85.5. black specks.  87.1-87.2 Py filled fractures 91.1 - 1cm 45° gtr vein very minor py.						
94.2	111.5	Tuff fragmental. grey silicified black streaks 95.7-96.6 - 1/2cm parallel gtr vein. 96.5-98.8 - fractured-reheated by silica & pyrite 101.87 - parallel fractures to 106						
111.5	113.9	→ 111.5 - 113.9 Altered speckled olive green - 2 shears with swelling material.						
113.9	115	Tuff grey poss. argillaceous matrix. pyc cubes						
115	115.29	Argillaceous material - broken.						
* 115.29	115.60	Poss. Valentine vein. Very impure gtr, gtr stringers & streaks mixed with argillite. Oxidized & bleached.	65072			0.003	0.05	
* 115.60	116.66	Quartz pseudotach zone. Prob. alteration zone. mixed with argillite mineral matrix, oxidized	65073			0.003	0.04	
* 116.66	118.04	Quartz pseudotach zone - altered argillite? minor py.	65074			0.003	0.04	
* 118.04	118.95	Quartz composite zone. oxidized, broken. more quartzy	65075			0.005	0.06	
118.95	129.47	Altered bleached volcanic? very soft from 121.85 - 129.38 talcy. Poss magnetite specks.						

M. E. Gold

Sheet No... 77-53....(2)

Co-Ords: 141.64N 139.99W

Azimuth: S 24° 30' W

Dip: -45° Test -52.5° Drill Type &amp; Size:

## The Agnes &amp; Dennis Mining Co. Ltd.

## Diamond Drill Record

Hole No. 77-54

Property: No Energy.

Location: F.G. 1 m.e.

Elevation:

Date Started: Aug 31, 1977

Length: 125.36 m.

Date Completed: Sept 2, 1977

Section:

Logged By: M. E. Botet

Purpose:

Date Logged:

Footage/Metres		Description	Sample No.	Footage/Metres		Length
From	To			from	to	
9.15	17.92	Argillite - impure - Tuffaceous sections - sheet. many narrow 55° gte stringers. Fine diss. pyrite Fault or shear. 1211-1311. too soft - altered.				
17.12	21.1.	Tuff or flow. pale grey/green. pyrochalcite spots. Fragmental last 40 cm.				
21.1	33.	Tuff with black streaks & patches - prob. mixed in argillite very similar to preceding except for black coloration. minor py cubes Prob. interbedded flows: light grey/green py specks gray. - white feldspar spots.				
33	39.2	27.8-28. Leached - very dark gte / gray. Argillite - Tuff mix. dark grey. parts totally black argillite parts - grey tuff.				
39.2	44.90	Argillite impure black. 43.8-44.0 5-3mm. 45° gte stringers py in argillite				
44.90	53.06	Tuff with parts argillaceous - last meter fragmental.				
53.06	55.6	Lepid. Tuff. dark matrix (argillite?)				
55.6	61.6	Many thin 45° barren gte stringers.				
	61.6					

Footage/Metres		Description	Sample No.	Footage/Metres			Length	Au	Ag
From	To			from	to				
61.6	68.93	Argillite $45^\circ - 60^\circ$ . bedding in places. Broken.							
61.6	68.93	talcy to 62.9 remainder hard but and glzy. Pyrite in vugs.							
68.93	71.6	Tuff. creamy/buff + grey. Black streaks patches. py diss/fine.							
		71.6 - 71.6 Fine py - upper sides of 4cm contact gtz vein.							
71.6	72.8	Tuff, greys with fine pyrite.							
72.8	78.9	Tuff silicified dark grey $30^\circ$ contact. 74.2 - 75.8 - gtz/carb veined area. Vuggy - coated with py. $30^\circ$ veining. gtz is more siliceous.							
		77.7 - 78.9 parallel rusty fracture coated with pyrite.							
78.9	82.54	Tuff or flow. pale green massive, few black streaks. Faults: 82.1; 84 - soft swelling; 84.7 mud.							
82.54	91.1	Flow green, massive $30^\circ$ lower contact. w.Th.							
91.1	93.6	Tuff - buff white feldspars? slightly oxidized							
93.6	95.4	Flow/Tuff - green as before. - 92.5 - 91.1							
		95.05 - 96.4 Silicified, grey.							
95.4	105.84	Flow breccia or Tuff grey/green - fragmental. Becomes more argillaceous after 105.6. Quartz stringers start 102.79 - with fine diss. py cubes 104.7 - 104.8 gtz vein - white $30^\circ$							
105.84	111.8	Tuff, dark grey, pyrite cubes, gtz stringers to 110.4 106.1 - 106.75. Qtz vein - $30^\circ$ contact with py vein. carbonaceous bands. Lower contact $35^\circ$	65076				0.304	0.70	
*	111.8	Qtz vein grey. Prob. $30^\circ$ lower contact very minor py.	65077				0.412	0.25	
*	112.43	Dyke.							
		over							

McB忘了

Sheet No. 77-54 (2) ....



Co-Ords: 296N - 699W  
90.28mN - 213.19mW

Azimuth: S

Dip: -70.5° Testat 41m = 82° Drill Type & Size:

Elevation: 1100

Length: 141.52 m.

Section:

Purpose:

The Agnes & Dennis Mining Co. Ltd.

Diamond Drill Record

Hole No.

17-55

Property: Erickson Gold Mining Corp.

Location: F.G.1 m.s.

Date Started: Sept 3, 1977

Date Completed: Sept 6, 1977

Logged By: M. B. B.

Date Logged:

Footage/Metres		Description	Sample No.	Footage/Metres	Length
From	To			from	to
0	4.58	overburden in casing			
4.58	20	Argillite - light + dark. bedding 50°. slump features.			
20	35.45	" " bedding abg. 60°			
		minar quartz 25-26m			
35.45	48.35	Argillite bedding 65°			
48.35	63.44	Tuff Grey, in part fragmental, very little black material.			
		59.2 - 61.4 parallel fracture or shear coated with soft white min.			
63.44	74.5	Tuff grey, more argillaceous from 66. to black streaks. 73.20 - 74 Fault zone. mud. Sharp 50° contact with impure argillite at 74.5			
74.5	79.30	Tuffaceous argillite			
79.30	84.5	Argillite crude bedding 60° rather impure.			
		78.4 - 83.5 Talc.			
84.5	86.45	or Tuff. grey.			
86.45	87.5	Silicified zone. dark grey			
87.5	87.84	Tuff - butt.			
87.84	88.55	Silicified zone dark grey, gla/scrch stronger.			
88.55	103.2	Flow or Tuff. pale green, greys, butt fine pyrite 88.55 - 89.4			
103.2	107	Tuff or Flow. similar to above, but fragmented and with more argillaceous matt. Argillaceous material in 60° bands to c.a.			

Footage/Metres		Description	Sample No.	Footage/Metres		
From	To			from	to	Length
107	107.65	Tuff grey with gte stringers		44	45	
107.65	108.1	Black lapilli Tuff.				
108.1	108.6	Tuff grey				
108.6	122.31	Quartz vein - predominantly white barren quartz, some carbonate & minor py. Less minor tetrahedrite. Wallrock inclusion at $60^\circ + 40^\circ$ to cleavage.				
108.6	109.1	minor ribboning carbonate $20^\circ + 60^\circ$ fractures. good solid quartz.	65080	.029	.06	
110.1	111.94	carbonaceous bands, slight orange oxidation. $1-20^\circ$ fracture with py.	65081	.016	.01	
111.94	113.2	barren white quartz. $2-30^\circ$ open fractures	65082	1.003	<.01	
113.2	115.4	" "	65083	1.003	<.01	
115.4	117.12	Lively quartz with semi parallel bands of carbonaceous material and orange oxidation. Includes 20cm of wallrock	65084	.012	.09	
117.12	118.3	similar to above	65085	.022	.01	
118.3	119.56	carbonaceous band, fairly orange. not parallel.	65086	.264	.1	
119.56	120.78	barren white quartz.	65087	.04	.09	
120.78	121.64	minor pyrite parallel fracture.	65088	.003	.1	
121.64	122.31	pyrite, rusty.	65089	.003	.05	
122.31	122.45	Dyke apophysis				
122.45	127.25	Tuff - grey, gte stringers, py cubes - change to.				
127.25	130.9	Argillite - impure broken. with 3 gte veins - shattered.				
*		128.5 - 130.9	65090	.003	.07	
	130.9	Dyke				
*	132.07	shattered gte fragments mixed with dyke fragments				
*	132.37	gneiss - appears to have $15-20^\circ$ upper contact with tuff.	65091	1.003	.02	
	133.37	Tuff, grey, gte stringers, py cubes.				
*	134.30	gneiss barren.	65092	1.003	<.01	
	135.79	Dyke commences as normal grey f.g. dyke but changes fairly quickly to m.g. biotite rich, green intrusive dyke slightly magnetic.				

H. G. Foster

Co-Ords: 296 N - 699 W  
90.28m N - 213.19m W

Azimuth: S

The Agnes & Jennie Mining Co. Ltd.

Diamond Drill Record

Hole No.

77-56

Dip:  $-51.5^\circ$  indicated depth  
at 106m  $66.5^\circ$

Drill Type & Size:

Property: Erickson Gold Mining Corp.

Elevation: 1100

Location: F.G. 1 m.s.

Length: 106.73

Date Started: Sept 6, 1977

Section:

Date Completed: Sept 8, 1977

Purpose:

Logged By: NB Botell

Date Logged:

Footage/Metres	From	To	Description	Sample No.	Footage/Metres			Length
					from	to	Length	
*	0	9.15	casing					
*	9.15	37.6	Argillite black-some white stamp features. bedding $40^\circ$					
*	37.6	63.4	Argillite much purer. mostly f.g. black. bedding $40^\circ$					
*	63.4	65.1	Argillite becoming tuffaceous					
*	65.1	71.80	Tuff - very argillaceous i.e. black.					
*	71.80	72.90	Quartz vein slight malachite stain - prob chalco speck. carbonaceous bands.	65083	.003	.05		
*	72.90	91.6	Tuff/Argillite bedding where vs. $55^\circ$ to c.a. greys. some marcasite Tally from 79.2 to 89.8					
*	91.6	93.1	91.6 - Silicified grey Tuff with gtz stringers					
*	93.1	98.27	Tuff or flow - grey, buff. bedding? $45^\circ$ 97.25 - 98.27 Fault contact with vein. argillaceous.	65094	0.20	.05		
*	96	97.75	Fault zone - core broken, soft + brown.					
*	98.27	98.87	Quartz vein. First 40 cm ribboned; with specks Au remainder barren white.	65095	1.188	9.20		
*		106.73	good chalco, tetrahedrite + minor sphalerite in ribboned section. poss. Jennie.					
*	98.87	106.73	Tuff/Argillite mix. with minor marcasite 105.58. Barren white $15^\circ$ gtz stringer. 4cm. wide					

Co-Ords: 296 N - ~~3441~~ 699 W  
90.28m N - 213.19m W

Azimuth: 5

Dip: -60° collar Dip test reads Drill Type & Size:  
-77.5° at 144.9m.

Elevation: 1100

Length: 148.54 m.

Section:

Purpose:

The Agnes & Dennis Mining Co. Ltd.

Diamond Drill Record

Hole No.

77-57

Property: Erickson Gold Mining  
Co. Ltd.

Location: F.G. 1 m.s.

Date Started: Sept 8, 1977

Date Completed: Sept 11, 1977

Logged By: J. B. Scott

Date Logged:

Footage/Metres		Description	Sample No.	Footage/Metres	
From	To			from	Length
0	9.15	casing		An	Ay
9.15	38.9	Argillite - dark + light slump fragments			
		Bedding 12.5m - 45°			
		20.5 - 45°			
		21-23m - gtz stringers			
		26.4 - 60°			
		31. - 45°			
		38 - 40°			
38.9	59.02	Argillite light stringers			
		44.7 - 35°			
		47 - 35°			
		Fault 54.1 - 58.8.			
		56.5 - 45°			
		recovery 57.04 - 58.71 = 20%			
59.02	63.5	Tuff, massive, grey black streaks			
		61.4 - 63.5. Good fine pyrite Prob. shear section 4% by			
		open 20° fault @ 63.5. marlposita 63.5 - 64.17			
63.5	64.17	Altered zone with marlposita			
64.17	66.34	Tuff, grey fragmental.			
		66.34 Fault - mud			
66.34	69.4	Tuffaceous Argillite py cubes to 6mm 1cm.			
69.4	80.0	Tuff, argillaceous matrix.			
		71.6 - 72 - 20° gtz veins barren			
		75.65 - 76.2 quartz veins + fillings barren			
		76.6 - 83.4 talcy - white grey py patches			
80	83.4	Argillite - bedded very talcy.			

Footage/Metres		Description	Sample No.	Footage/Metres		Length	An	Ag
From	To			from	to			
83.4	94.8	Argillite bedding 45°. Probably talcaceous mud seam at 83.4; 84.2 93.2 - 94.8 Altered, hard, greenish - mott mariposite specks						
94.8	98.6	Tuff/Argillite hard dark grey. minor mariposite 98.1 ruggy shear.						
98.6	99.74	Argillite - prob fault zone ruggy quartz stringers	65098				0.003	0.04
99.74	101.45	Altered broken gts stringer zone. 35° to core.						
* 101.45	102.15	Quartz vein white, one rug with chalcotetrahedrite alongside. lower contact 30° to c.a.	65097				0.032	0.08
102.15	102.50	Fault - shattered.						
102.50	107.0	Flow or Tuff: pale greenish buff's fragmented ochreous. black streaks, bands.						
	107.1 - 108	semi parallel fracture with pyrite.						
110.8		Minor grey shear - contact.						
110.8	111.38	Tuff dark grey massive.						
114.38	114.6	Tuff but with green speckles to start then overriding tone. no actual contact. spots of mariposite.						
120.6	120.68	116.7 gts stringers begin end at 121. Tuff, grey, silicified						
123.68	124.3	Fractured, ruggy section filled with gts/calc.						
123.68	125.95	Argillite - dark. minor, small, py cubes						
125.95	126.25	Fault. mud. contact.						
126.25	127.98	Altered salt argillaceous rock - white/grey fragments - 133.64 - 133.90 Argillaceous-dark section.						
134.98	135.25	Dyke - black. (mariposite)						
136.05	136.3	Altered sediment, whitish black specks. Soft, excellent core. Same materials as in bottoms of other deeper holes. slight pyrite 136.30 - 136.40						
143	148.54	Volcanic flow - Transition zone 143 - 144 - 40° gts vein 6cm pale green, blotchy. Hard: no minerals end of hole						

101.45 102.15 Ots vein is probably same as 77-56: 71.8 - 72.9

M. G. Burt

Sheet No. 77-57... (2)...

Co-Ords: 896N - 099W.  
90.3mN - 213.19mW  
Azimuth: S 30 W

The Agnes & Dennis Mining Co. Ltd.

Diamond Drill Record

Hole No. 77-58

Dip: -45° collar. True - 60° at 402' Drill Type & Size:  
122.61m

Location: F.G. 1 m.c.

Elevation:

Date Started: Sept 11, 1977

Length: 122.61m

Date Completed: Sept 14, 1977

Section:

Logged By: JG Botel

Purpose:

Date Logged:

Footage/Metres		Description	Sample No.	Footage/Metres		Length	Au	Ag
From	To			from	to			
0	10.37	casing						
10.37	39.3	Argillite - light & black. bedding 15.8m 30° to ea. fragments of light banded rock. 30m 30° 36.5m 30°						
39.3	52.3	Argillite - same but solid. broken 52.9 - 54.6 leached 56.5 Fault 58.8 - 60.1 10° uncon.	47.5 50	20° 30° varies.				
				rock is folded so attitudes vary quickly.				
69.3	83.15	Argillite : same. bedding after 79m is 60° 81.4 - 81.6 gtz section with minor massive 82.1 - 82.5 Fault.						
83.15	92.6	Argillite/Tuff greyish laminated, talc. py. cubis. Talc to 98.0m Bedding or laminations 25-60°						
90.6	98.4	Tuff - more massive, gtz stringers broken argillaceous sections 91.5-91.65 - gtz vein - white barren. 92.2 - 92.5 (gtz vein - ribboned, chalco, tetra, py. Au.)	65100	92.2	92.5	18.08	5.36	
		over.						



Co-Ords: 90.28m N - 213.19m W

## The Agnes &amp; Dennis Mining Co. Ltd.

Hole No. 77-59

Azimuth: S 6° W

## Diamond Drill Record

Property: Erickson Gold Mining Corp

Dip: -45° Test 340' - 57.5° Drill Type & Size:  
103.7m

Location: F.G. 1 m.c.

Elevation: 1110'

Date Started: Sept 14, 1977

Length: 103.70 m

Date Completed: Sept 19, 1977

Section:

Logged By: WB Both

Purpose:

Date Logged:

Footage/Metres		Description	Sample No.	Footage/Metres		Length	Au	Ag
From	To			from	to			
0	12.20	casing						
12.20	41.91	Argillite - broken, black & light fragments bedding 45°? in places parallel 31.7-39 more tabular 39.5 2 cm 50% pyrite						
41.1	72.87	Argillite black & light less fragments. very solid. bedding semi parallel? 50.5 bedding 40° facia 69. minor quartz						
72.87	73.95	Dyke - grey diss py. 73.0 good fine py 2 cm 90° 69.24-72.87 leached ruggy						
73.95	81.44	Argillite - sheared, slickensided - "washers" 60°						
81.44	83.27	78.4-81.44 talc, soft.						
83.27	92.75	Tuff massive, grey						
92.75	96.2	Flow or Tuff - pale green						
96.2	96.58	Tuff siliceous, grey Qtz stringers 25°-40° Qtz vein carbonaceous veining	68251				0.003	0.22
96.58	103.70	Qtz vein orange spots, Tuff inclusions, chalco, sphalerite Tuff & flow. grey/buffs, Qtz stringers @ 97.91-97.98-95° 98.125-98.33-20°; 98.52-3cm 38°; 101.2-101.3-35° 103.40-103.5 25°. All have carbonate but barren.	68252				0.068	0.05
*	99.1-99.84	- Barren Qtz. one pyrite stringer	68253				0.012	0.04
	101.3-101.75	- Barren white Qtz	68254				0.003	0.01
	99.84-100.65	- Tuff with ~4% py. - one coarse parallel 2-3cm Qtz stringer 40cm	68255				0.006	0.04

Sheet No. ....

Co-Ords: E-14E-324m - N 19,482m

## The Agnes &amp; Dennis Mining Co. Ltd.

Hole No.

77-60

Azimuth: S

## Diamond Drill Record

Dip: -45

Drill Type &amp; Size:

Property: Erickson Gold Mining Corp.

Elevation: 553.223m

Location: F.G. 1 m.s.c.

Length: 72.90

Date Started: Sept 29, 1977

Section:

Date Completed: Oct 2, 1977

Purpose:

Logged By: W. B. Bott

Date Logged:

Footage/Metres		Description	Sample No.	Footage/Metres		Length	Au	Ag
From	To			from	to			
0	9.15	casing						
9.15	21.05	Argillite - predom gray - parallel bedding to 20°						
21.05	29.00	Argillite - black + white (lags). fragmental to 29.00 bedding 40°						
29.0	38.0	Argillite - interlayered gray & black pure forms bedding about 10°?						
38.0	58.5	Argillite black+gray - mostly black. thin bedded in places bedding varies from 90° to 30° avg. 50°						
58.5	63.75	Argillite - very black. vuggy leached. 59.8 - 62.5 bedding ≈ 70° very thin minor gne stringers						
* 63.75	64.26	Quartz Vein last 6" banded. tho very poorly mineralized rusty orange. minor py. poss. 10% lost.	68257				0.01	0.05
64.26		Argillite / Tuff. thick laminated marlspite to 66. 66.8 - 72.90 talcy.						
71.2		71.2 - 72.9 mostly white rbs salt. more or less laminated diss. by clstc.						

Co-Ords: W 146.324m N 19.482m  
Azimuth: 5

Dip: -60 Test 246° - 72° Drill Type & Size:  
75.03m

Elevation: 553.223m

Length: 75.34

Section:

Purpose:

The Agnes & Jennie Mining Co. Ltd.

Diamond Drill Record

Hole No.

77-61

Property: Erickson Gold Mining Corp.

Location: F.G. 1 m.c.

Date Started: Oct 2, 1977

Date Completed: Oct 3, 1977

Logged By: M. G. Bobbit

Date Logged:

Footage/Metres		Description	Sample No.	Footage/Metres	Length	An	Ag
From	To			from	to		
0	9.15	Casing					
9.15	33.55	Argillite black with grey fragments slumpy. 12.39 - 20 mostly grey 20 - 33.55 badly broken.					
33.55	40.4	Argillite - blocky with grey laminations, more massive. bedding 70° 35.6 - 36.4 barren white gte. stringers.					
40.4	47.1	Argillite - mostly black massive. 42.1" py in gte.					
47.1		Argillite - grey with black. bedding 70° 52.5 - 55.9 leached ruggy					
* 59.3	59.78	Qtz vein. white - much carbonaceous mat. minor sphalerite, tetrahedrite, pyrite. no vis. An	68258			0.003	0.28
59.78	71.44	Tuffaceous Argillite. 66.92 - 66.75 Talc.					
	69.95	2" mud flint gorge)					
71.44	75.34	Volc. light green. very odd spack chalco altered to 75.13					

Co-Ords: W 146.324m N A.482

## The Agnes &amp; Dennis Mining Co. Ltd.

Hole No.

77-62

Azimuth: S

## Diamond Drill Record

Dip:  $-82^\circ S$  Test of 233' =  $85^\circ$  Drill Type & Size:  
 $-86^\circ W$  70.76m

Property: Erickson Gold Mining Corp.

Elevation:

Location: F.G. 1 mi.

Length: 71.68

Date Started: Oct 4, 1977

Section:

Date Completed: Oct 7, 1977

Purpose:

Logged By: MCleod

Date Logged:

Footage/Metres		Description	Sample No.	Footage/Metres		Length	Au	Ag
From	To			from	to			
0	9.76	casing						
9.76	19.67	Argillite black with grey fragments						
19.67	34.16	Argillite black with grey laminations. fine grain bedding 20m $60^\circ$ 23m $5^\circ$ 25.62 $50^\circ$ 31.5 $35^\circ$						
34.16	38	Argillite black with grey fragments						
38	42.8	Argillite 42.14 Fault - qtz stringer - Fault starts at 41.3 - 42.6 41.3 10mm qtz stringer						
42.8	44.84	Argillite thin bedded. $70^\circ$						
44.84	53.35	Argillite black with grey/white fragments - broken in part. whiteish hair stringers						
53.35	55.17	Dyke, green white eyes. cor. grain. (see 77-55 139.2m)						
55.17	57.3	Dyke, grey white eyes in part.						
57.3	60.77	55.3 - 55.6 Fault with quartz dyke + argillite.						
60.77	61.4	Argillite black with grey bands						
61.4	62.9	Dyke, grey						
62.9	64.36	Argillite, white hair veins, dyke apophyses						
64.36	64.9	Dyke, vein grey, shattered.						
64.9	65.85	64.9 - 65.85 Qtz vein Tetra, sphalerite, poss. 2 specks Au. 15% loss of sample	68259				0.404	0.34
65.85	66.10	Qtz vein minor scattered tetrahedrite, sphalerite	68260				0.003	0.18
66.10 - 68.7	68.7 - 71.68	Qtz vein minor but better " "	68261				0.01	0.56
Tuffaceous Argillite talcy with galena mineral micaceous End.								

Co-Ords: W. 11810 m S 24.042 m

Azimuth: 5

Dip:

$-87\frac{1}{2}$

Drill Type & Size:

Diamond Drill Record

Elevation:

Length: 92.42

Section:

Purpose:

The Agnes & Dennis Mining Co. Ltd.

Hole No.

77-63

Property: Eureka Gold Mining Corp.

Location: F.G. 1 m.c.

Date Started: Oct 7, 1977

Date Completed: Oct 10, 1977

Logged By: W. B. G. T.

Date Logged:

Footage/Metres		Description	Sample No.	Footage/Metres	Length	Au	Ag
From	To			from	to		
0	15.25	... <del>core</del> <sup>core</sup> ing					
15.25	35'	Argillite grey & black bedding @ 26m - 55°					
35	45.75	Argillite grey & black - grey fragments Quartz stringers 35.5 - 38.5'					
45.75	50.5	Argillite grey & black; white veinlets; bedding 70-80° Grey bottom 49.41 - 50.5					
50.5	53.05	Py vein 1" tabularite - prob. remnants of Tennis - Val. 68262				0.658	1.76
53.05	58.8	Tabular argillite					
58.8	72.29	Lapilli Tuff at Valc breccia brownish & green/gray Volc. green/gray f.g. 62.25 - 62.7 Py zone.				10.003	0.01
62.5	64.2	Kaolinized, green, section. soft. poor serpentinitized					
72.29	83	70.6 m. 2cm. 30° gray py vein Crossbed tuff at volc. greenish - green spots-alteration black hair stringers					
83	92	Volc. gray/green fine grained					
92	92.42	Lapilli tuff gray/green. End.					



Co-Ords: W 682' N 70'  
208.01m W 21.35m N

Azimuth:

Dip: -88° S -86° E Tilt 366' = -89° Drill Type & Size:  
111.63m

Elevation: 1298'

Length: 111.94

Section:

Purpose:

The Agnes & Dennis Mining Co. Ltd.

Diamond Drill Record

Redrill 77-64

Hole No. 77-65

Property: Erickson Gold Mining Corp.

Location: F.B. 1 m.s.

Date Started: Oct 11, 1977

Date Completed: Oct 14, 1977

Logged By: W.C. Batek

Date Logged:

Footage/Metres		Description	Sample No.	Footage/Metres	Length	An	Ag
From	To			from	to		
0	19.83	Casing					
19.83	26.6	Argillite grey + black. bedding 5° to 90° ang. 45°					
26.6	31.72	Argillite black with grey fragments 26.75-27.8 shear.					
31.72	39.5	Argillite - grey + black. broken in part -39.5					
39.5	53.07	33.8 - 34.3 shear.					
53.07	54.6	Argillite black with grey fragments bedding poss. 45°					
54.6	57.8	Argillite grey + black bedding 60°					
57.8	59.0	Argillite black with grey fragments (larger) Dyke green rarer white min. hematite, red hematite specks not magnetic. Grade slightly to f.g. grey dyke similar to vein dyke.					
59.0	59.1	Sheeted argillite					
59.1	68.1	Argillite, grey + black bedding @ 59.5 - 5°. 265° - 60° minor gte stringers					
68.1	70.1	Dyke green (57.8 similar) but no grey dyke.					
70.1	87.0	Argillite black + grey solid bedding @ 60° carries on to black argillite - minor grey fragments. solid					
87.0	87.9	Argillite black + grey + black - Leached, ruggy. gtz pebbles	68264			0.003	0.22
87.9	91.95	Dyke, grey					
91.95	92.11	Quartz vein Jennie/Valentine. white with mixed in wall rock - oxidized. pyrite minor. no vis An	68265			0.003	0.06
*	92.11	Peak looking vein.					



Co-Ords: W 682' N 70'  
208.01m W 21.35m N

Azimuth: S  
same location as 77-64, 77-65.

Dip: -60 S Tilted 343° -70.5° Drill Type & Size:

Elevation: 1228'

Length: 106.45

Section:

Purpose:

# The Agnes & Jennie Mining Co. Ltd.

## Diamond Drill Record

Hole No.

77-66

Property: Erickson Gold Mining Corp

Location: E.G. I m.c.

Date Started: Oct 14, 1977


Date Completed: Oct 16, 1977 0

Logged By: M. Batek

Date Logged:

Oct 18, 1977. Crew left camp.

Footage/Metres		Description	Sample No.	Footage/Metres		Length	
From	To			from	to		
0	21.35	casing					
21.35	49.82	Argillite, black with plentiful gray fragments & bands. bedding predom. 45° to ca. but folded.					
49.82	66.8	Argillite, mostly gray some black. <sup>solid</sup> : bedding varies predom. 35°					
66.68	86.4	Argillite, blacker some gray. <sup>solid</sup> 69.12-69.24 quartz + stilbite, barren bedding 40°-55° 76.45-77.2 broken (shear)					
		78.8-84.6. leached, vuggy. vein should have been after 84.6.					
		Section 84.49 - 86.01 Recovery 7m / 1.52. vein not indicated by core. no evidence of grinding - Poss. void					
86.4	88.6	Tuffaceous Argillite minor, gts					
88.6	106.45	Highly altered (chloritized) Volc breccia or Tuff breccia. green. many basalite white veinlets minor pyrite patches of unaltered rock or breccia fragments. Asbestiform mineral @ 106.35					
		END					

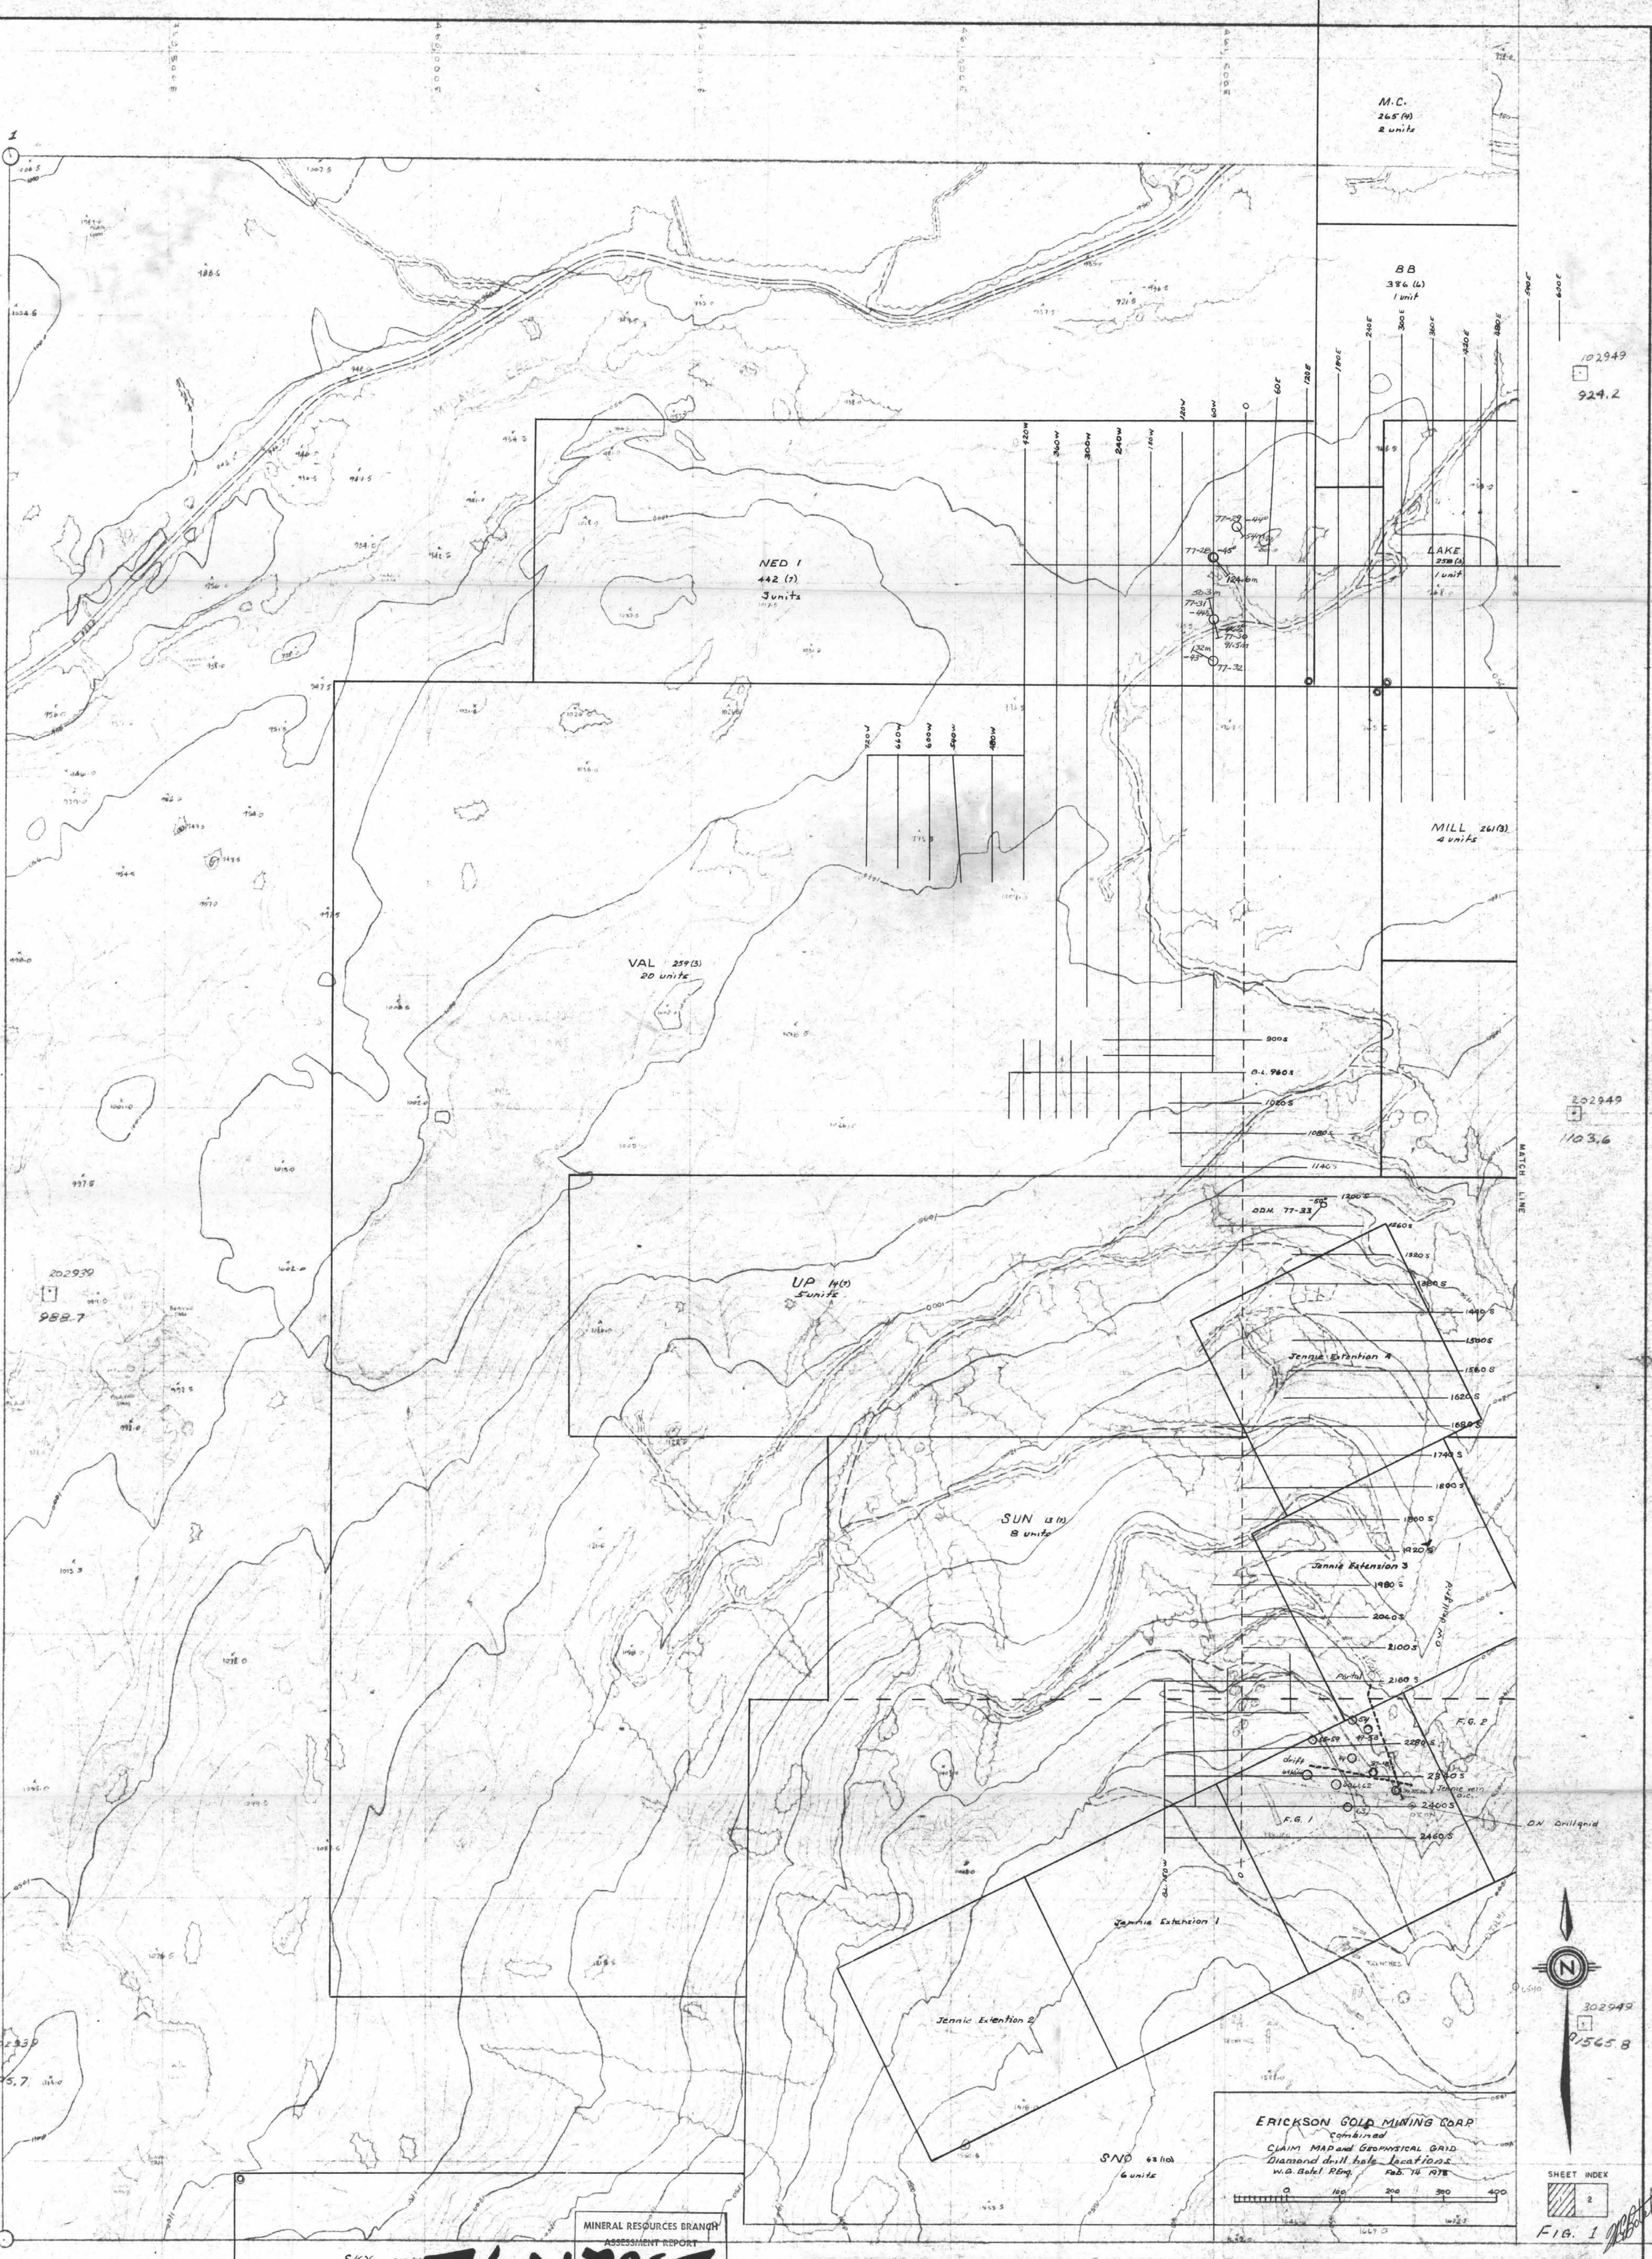

MINERAL RESOURCES BRANCH  
ASSESSMENT REPORT  
**7601 BACK**  
NO.

Scale and elevation datum based on limited ground control resulting in good relative, but uncertain absolute map accuracy.  
Compiled from aerial photography at an approximate scale of 1 inch equals 3300 feet flown in 1975

NEW ENERGY DEVELOPMENT CORPORATION

McDAME CREEK

PRELIMINARY RECONNAISSANCE TYPE MAPPING



McElhanney Surveying & Engineering Ltd.  
1200 West Pender Street, Vancouver, B.C., Canada

Scale - 1:5000

Contour Interval - 10 METRES


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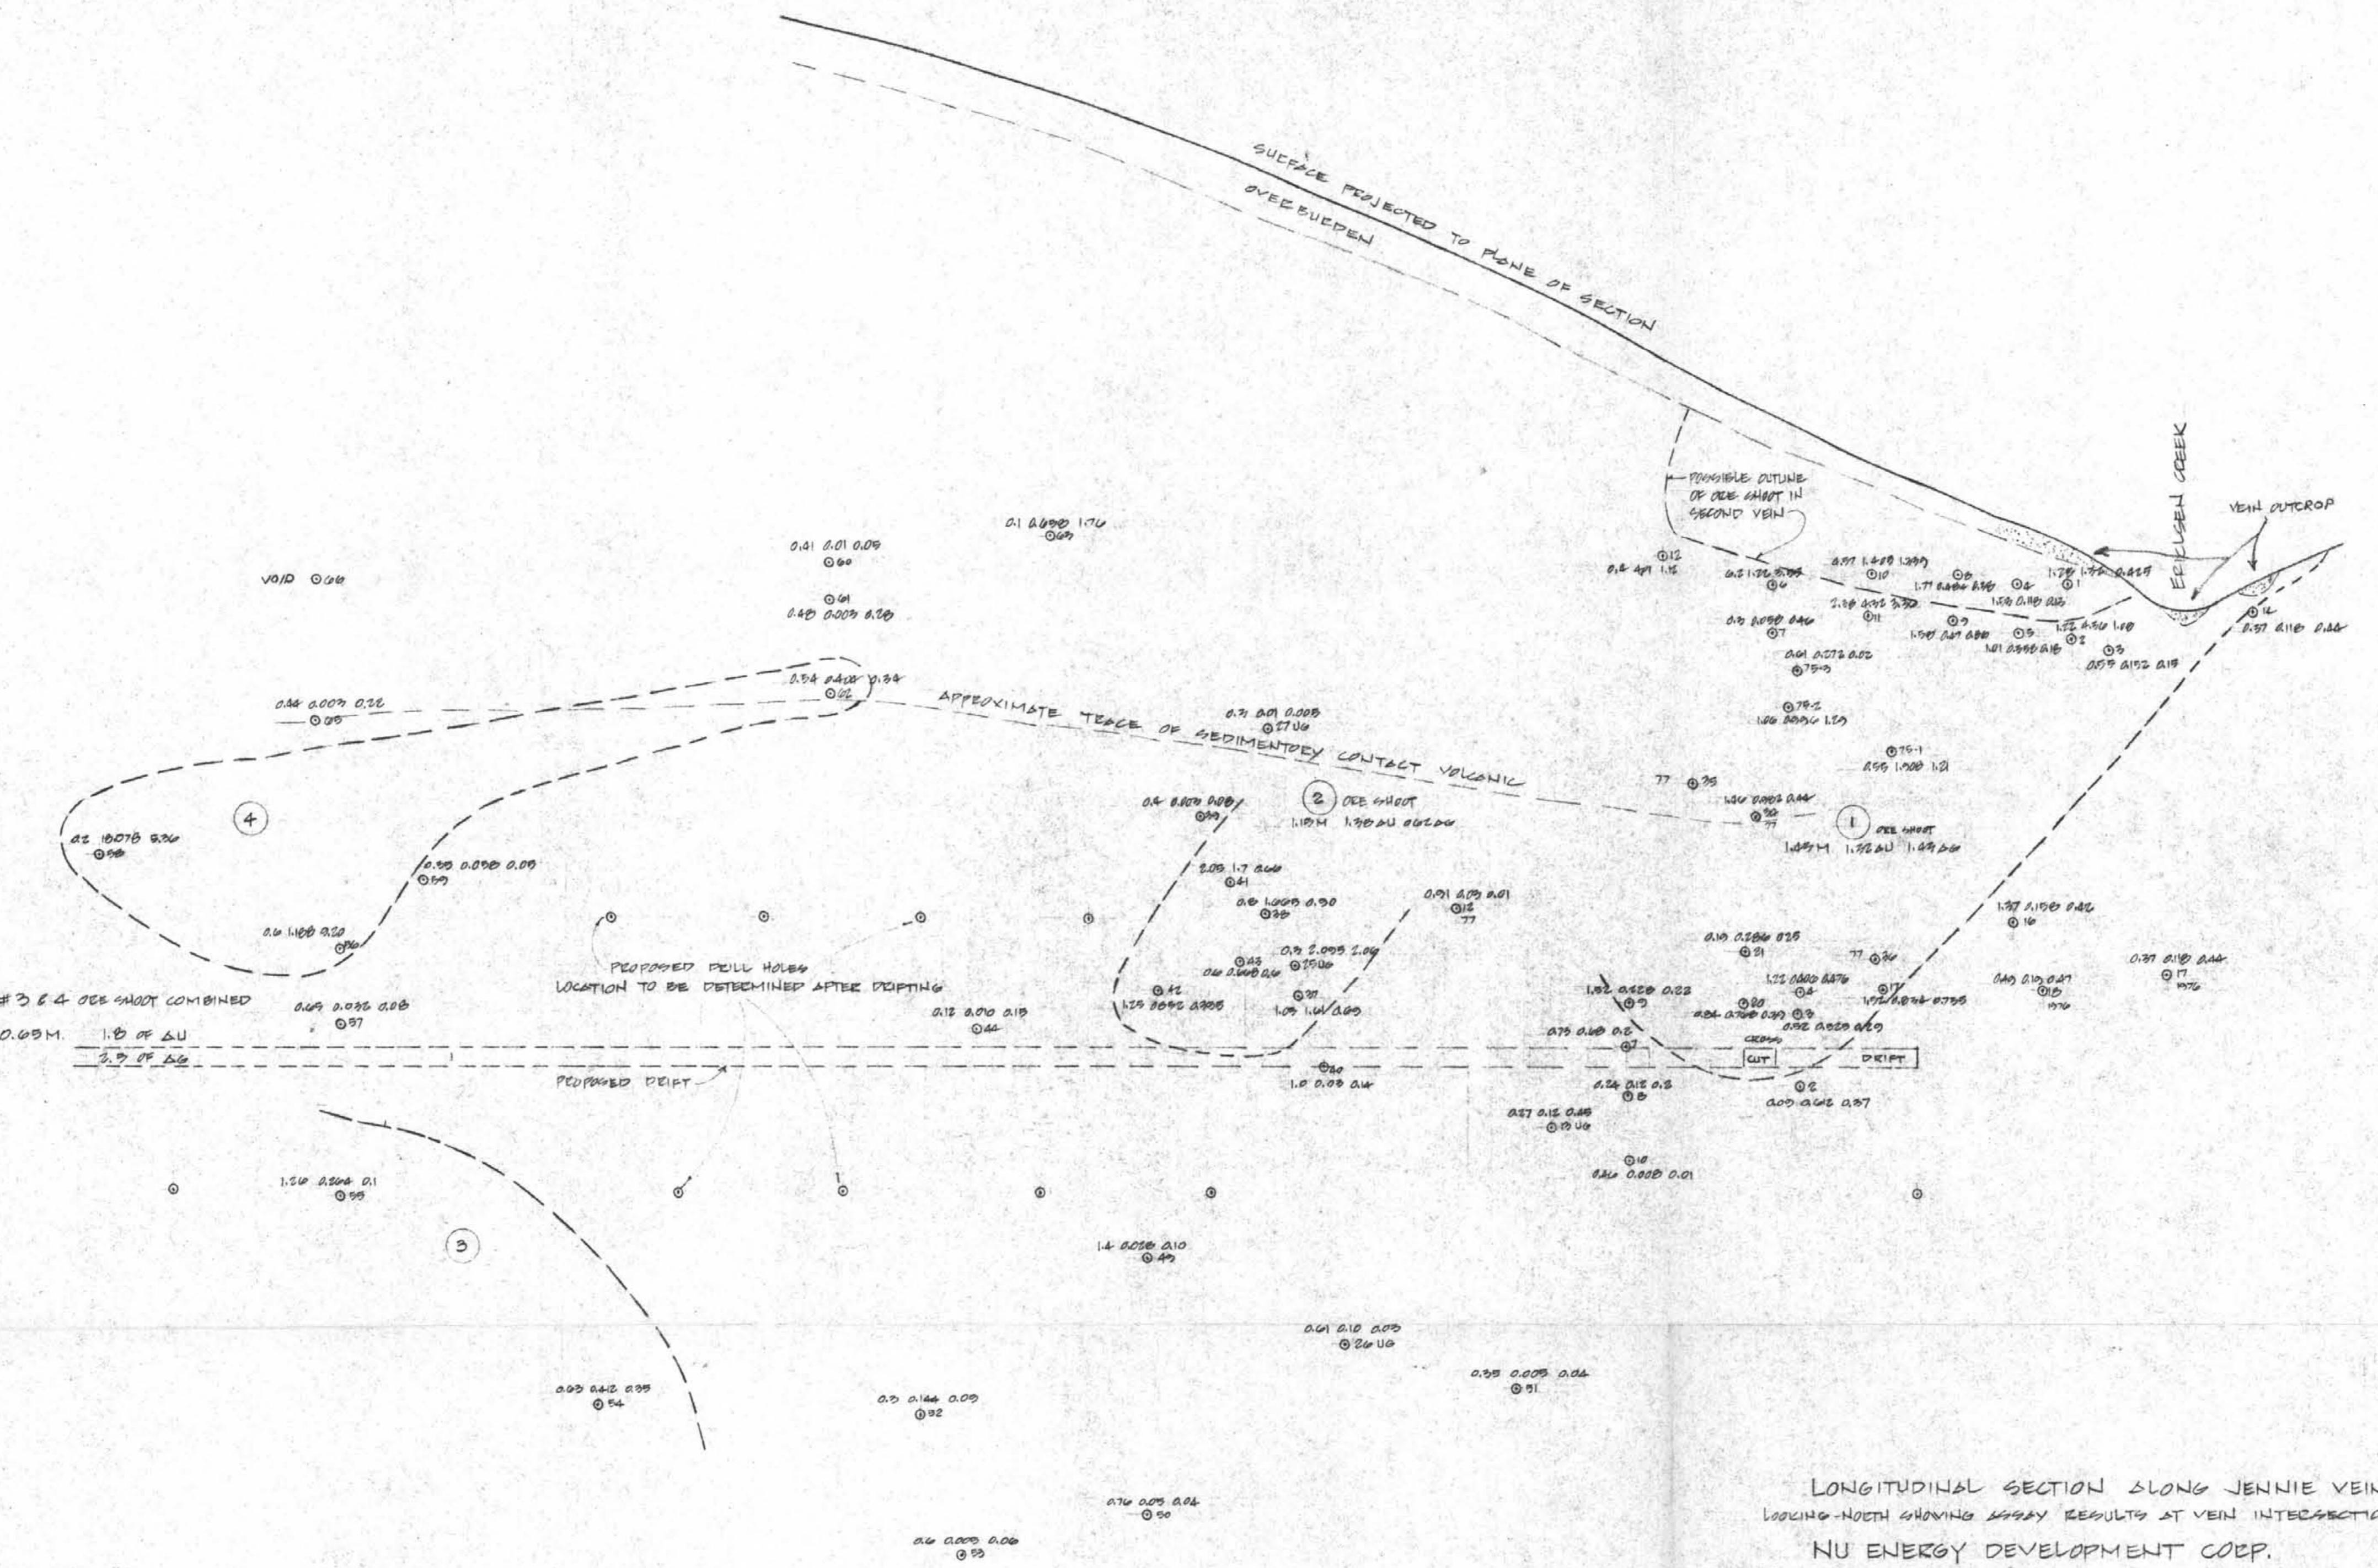
Job No. - D6370 - 0

Sheet No. 1 OF 2

SHEET INDEX  
2

FIG. 1



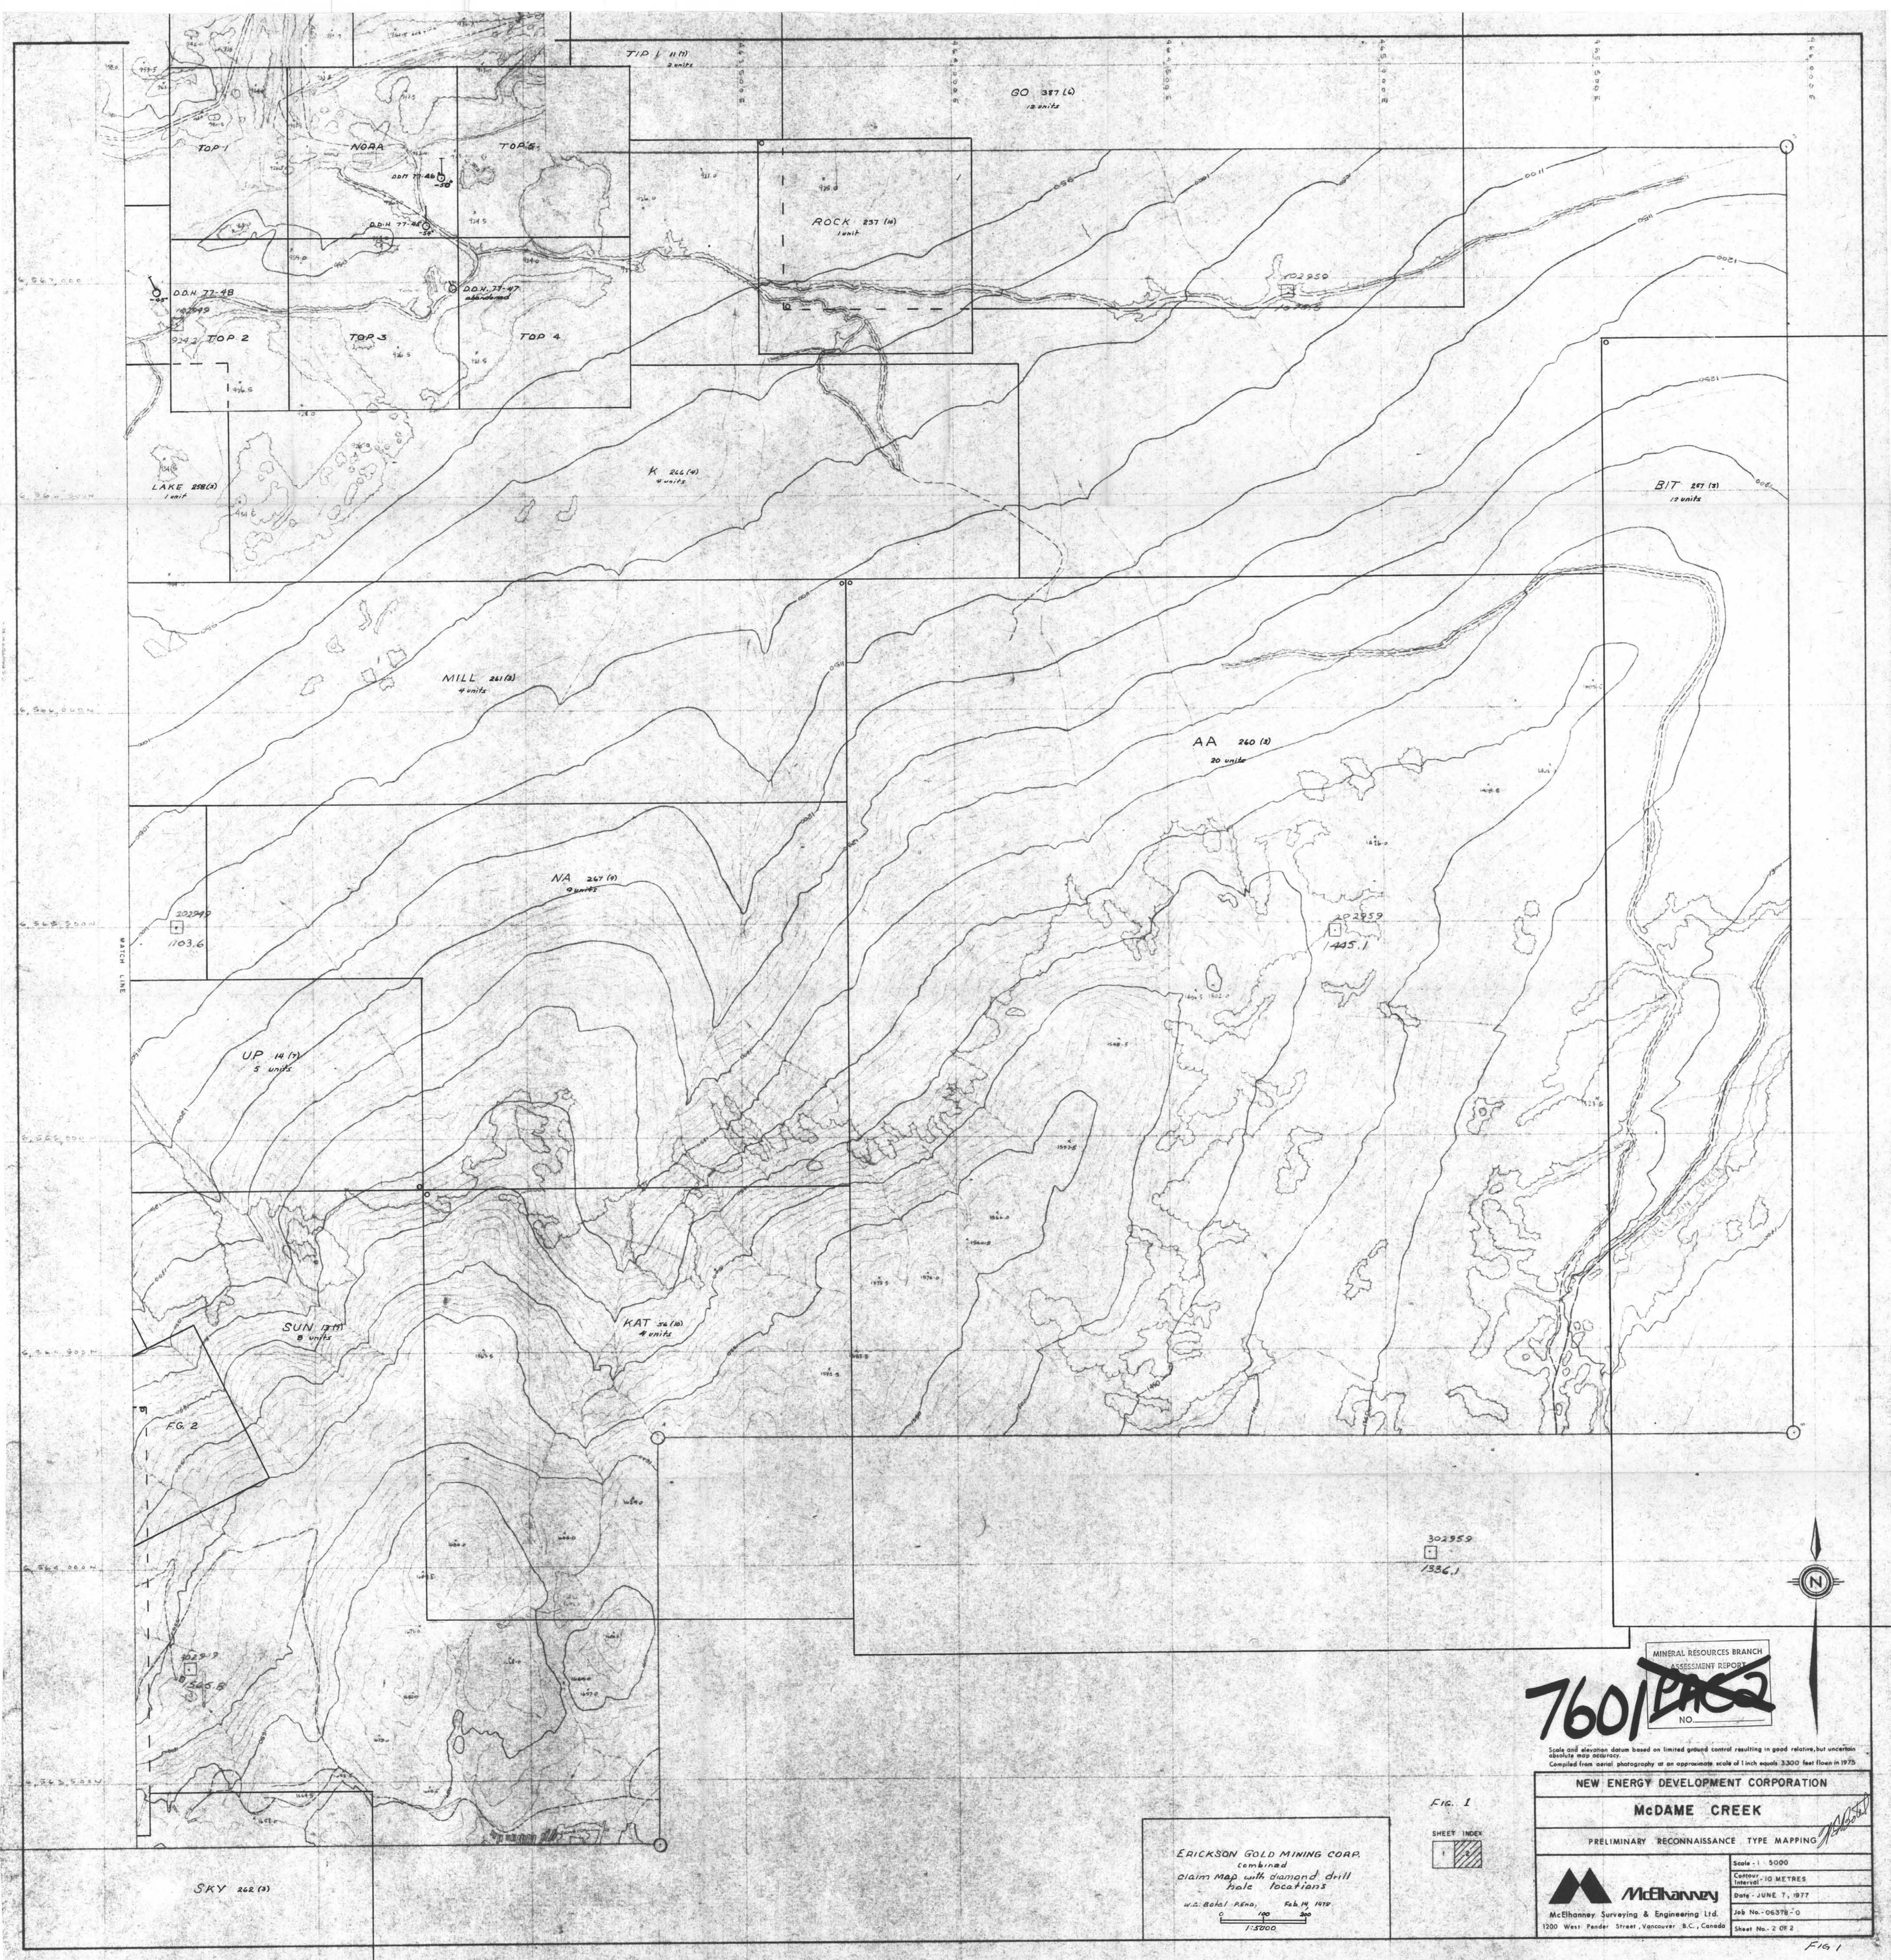

MINERAL RESOURCES BRANCH  
ASSESSMENT REPORT  
**7601**  
NO.

*Black*

FIG. 11